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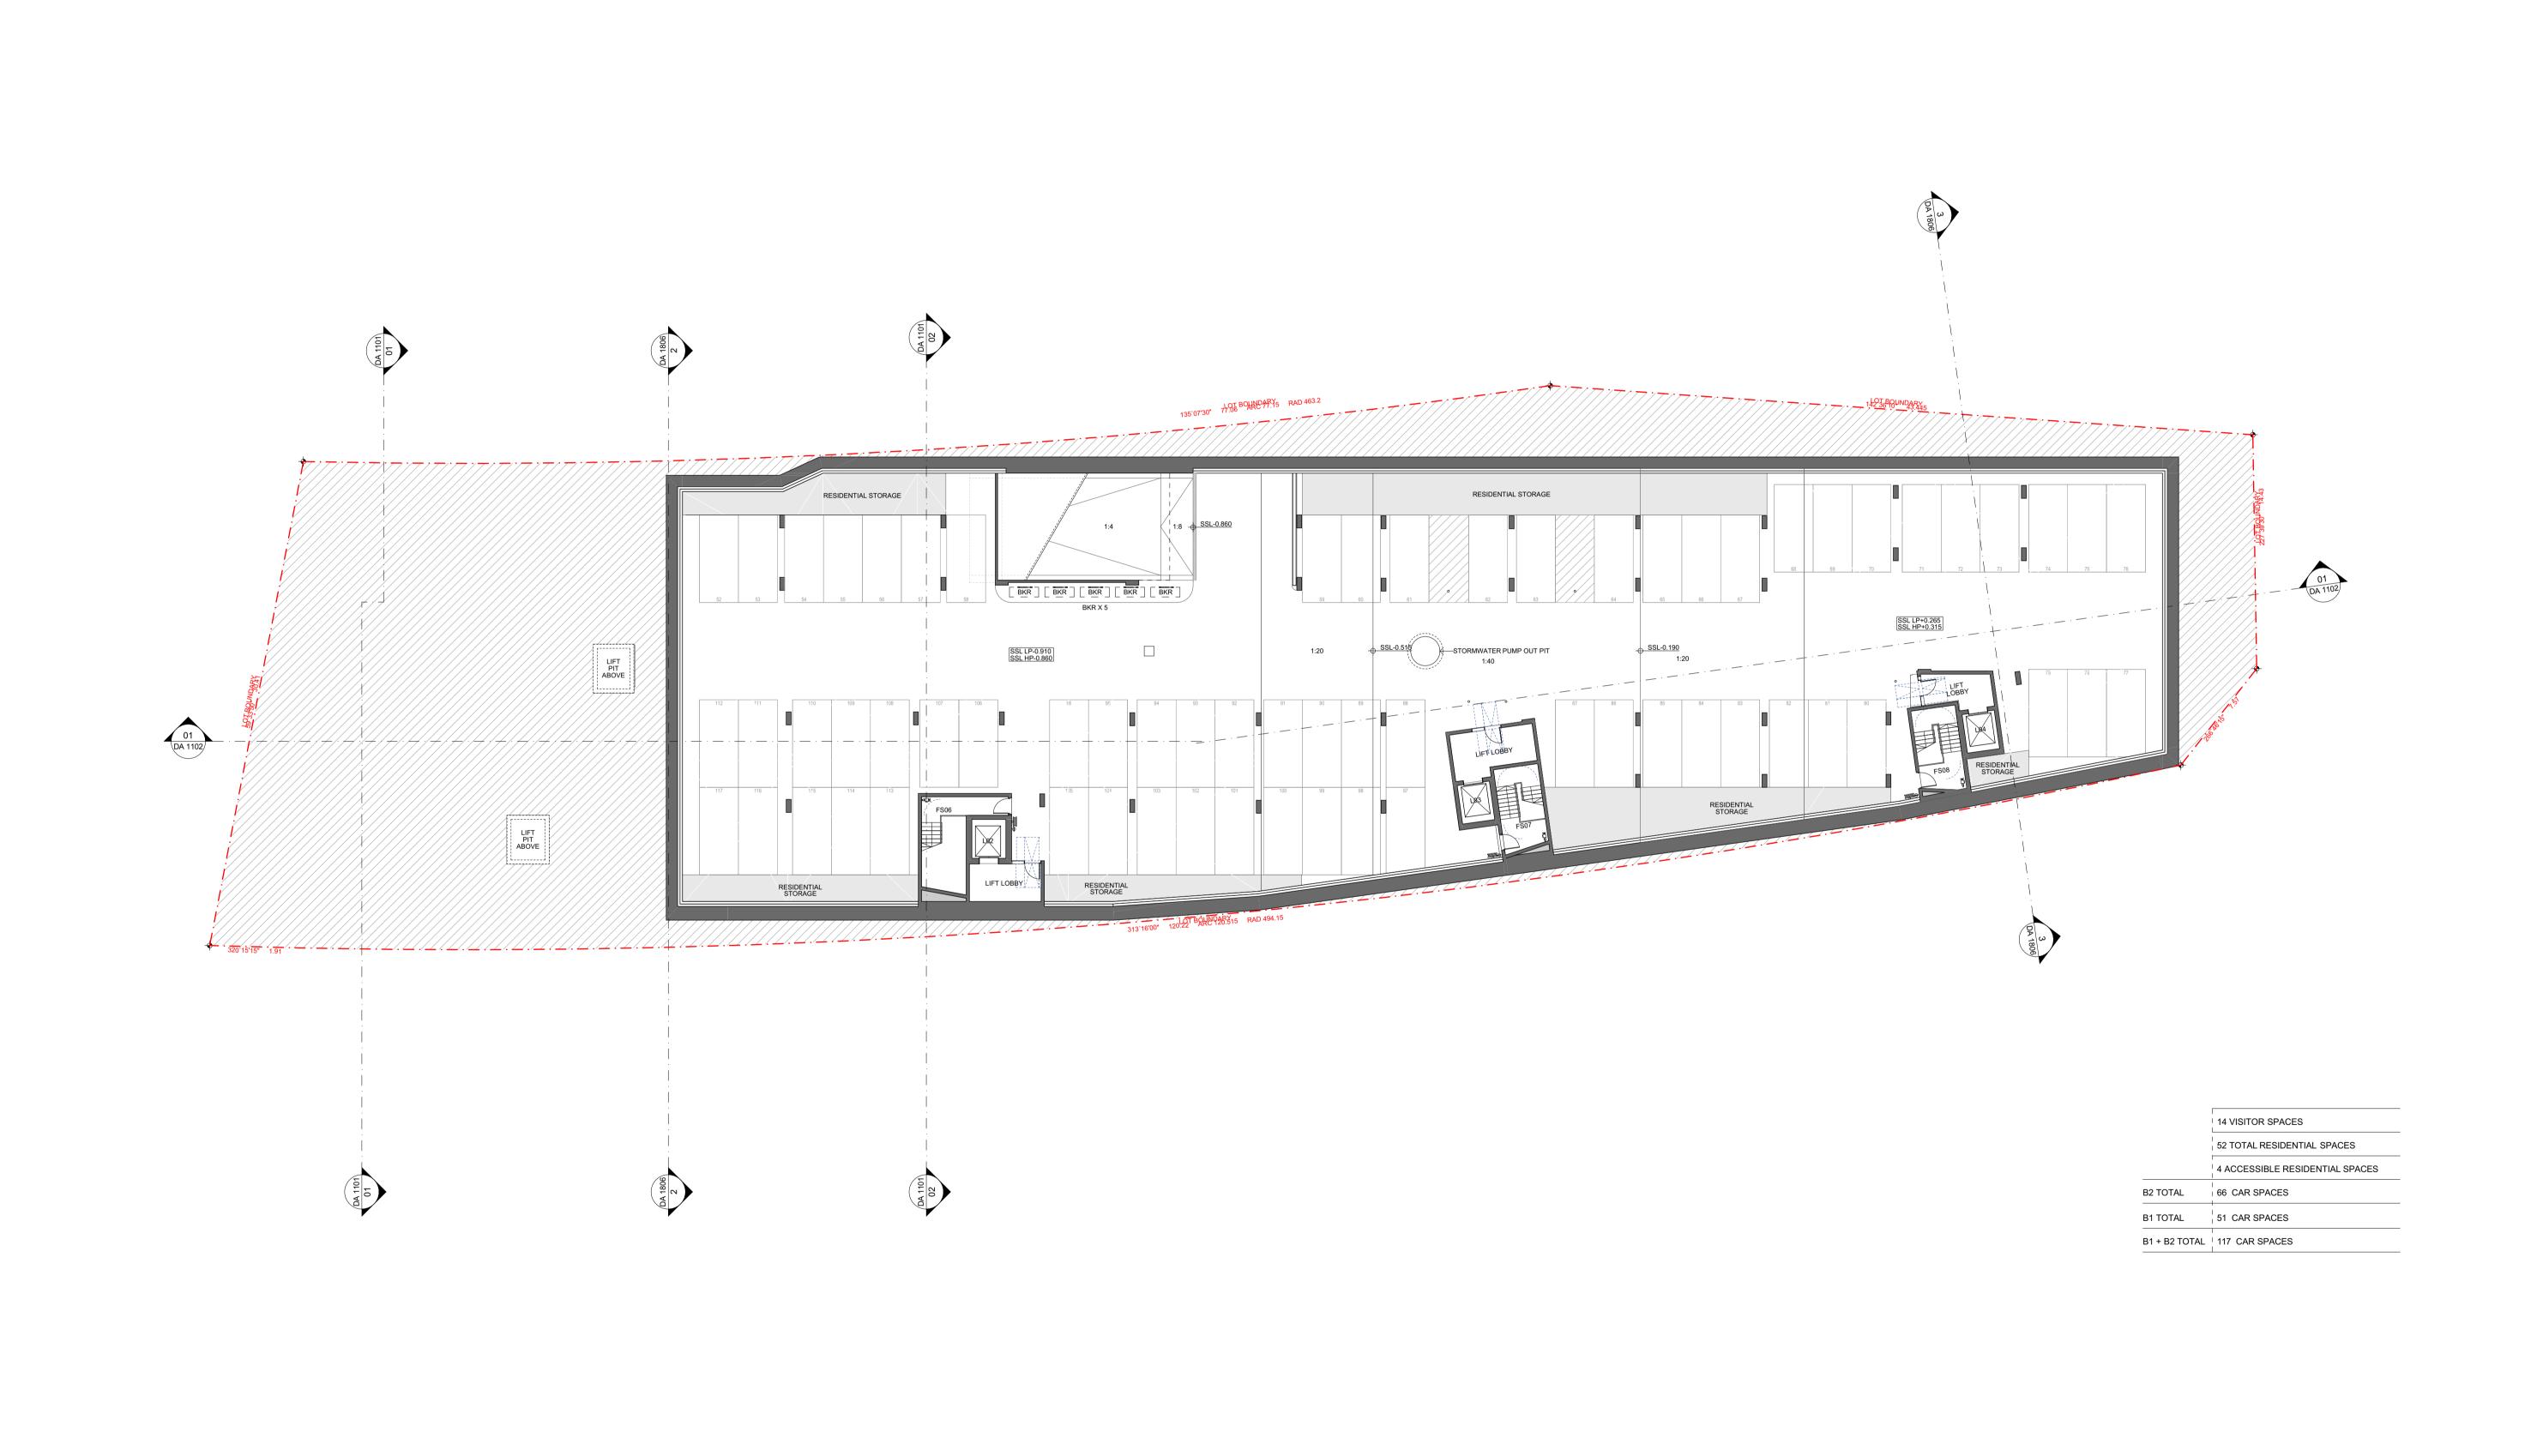
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4/	

	Project:					Architect:
	PRECINCT C	2 SHELL COVE				Candalepas Associates
	Site:					Registration No. NSW 5773 Registration No. VIC 17978
	PRECINCT C	2 SHELL COVE				Registration No. WA 2405
\forall	Client:					Registration No. ACT 2603 Registration No. QLD 5463
	FRASERS PR	OPERTY PTY LIM	ITED			309 Sussex Street, Sydney NSW 2000
	Scale:	Drawn By:	Checked 1:	Checked 2:	Approved:	info@candalepas.com.au
	1:500 @ A1	MK / KM	KM	KM	AC	T: 02 9283 7755 F: 02 9283 7477

	NOT FOR CONSTRUCTION	N - DESIGN INTENT ONLY
Architect:	Drawing:	Job Number:
Candalepas Associates Registration No. NSW 5773 Registration No. VIC 17978	SITE ANALYSIS	5965
Registration No. WA 2405		
Registration No. ACT 2603 Registration No. QLD 5463	Drawing Number:	Issue:
309 Sussex Street, Sydney NSW 2000 info@candalepas.com.au	DA 0101	С



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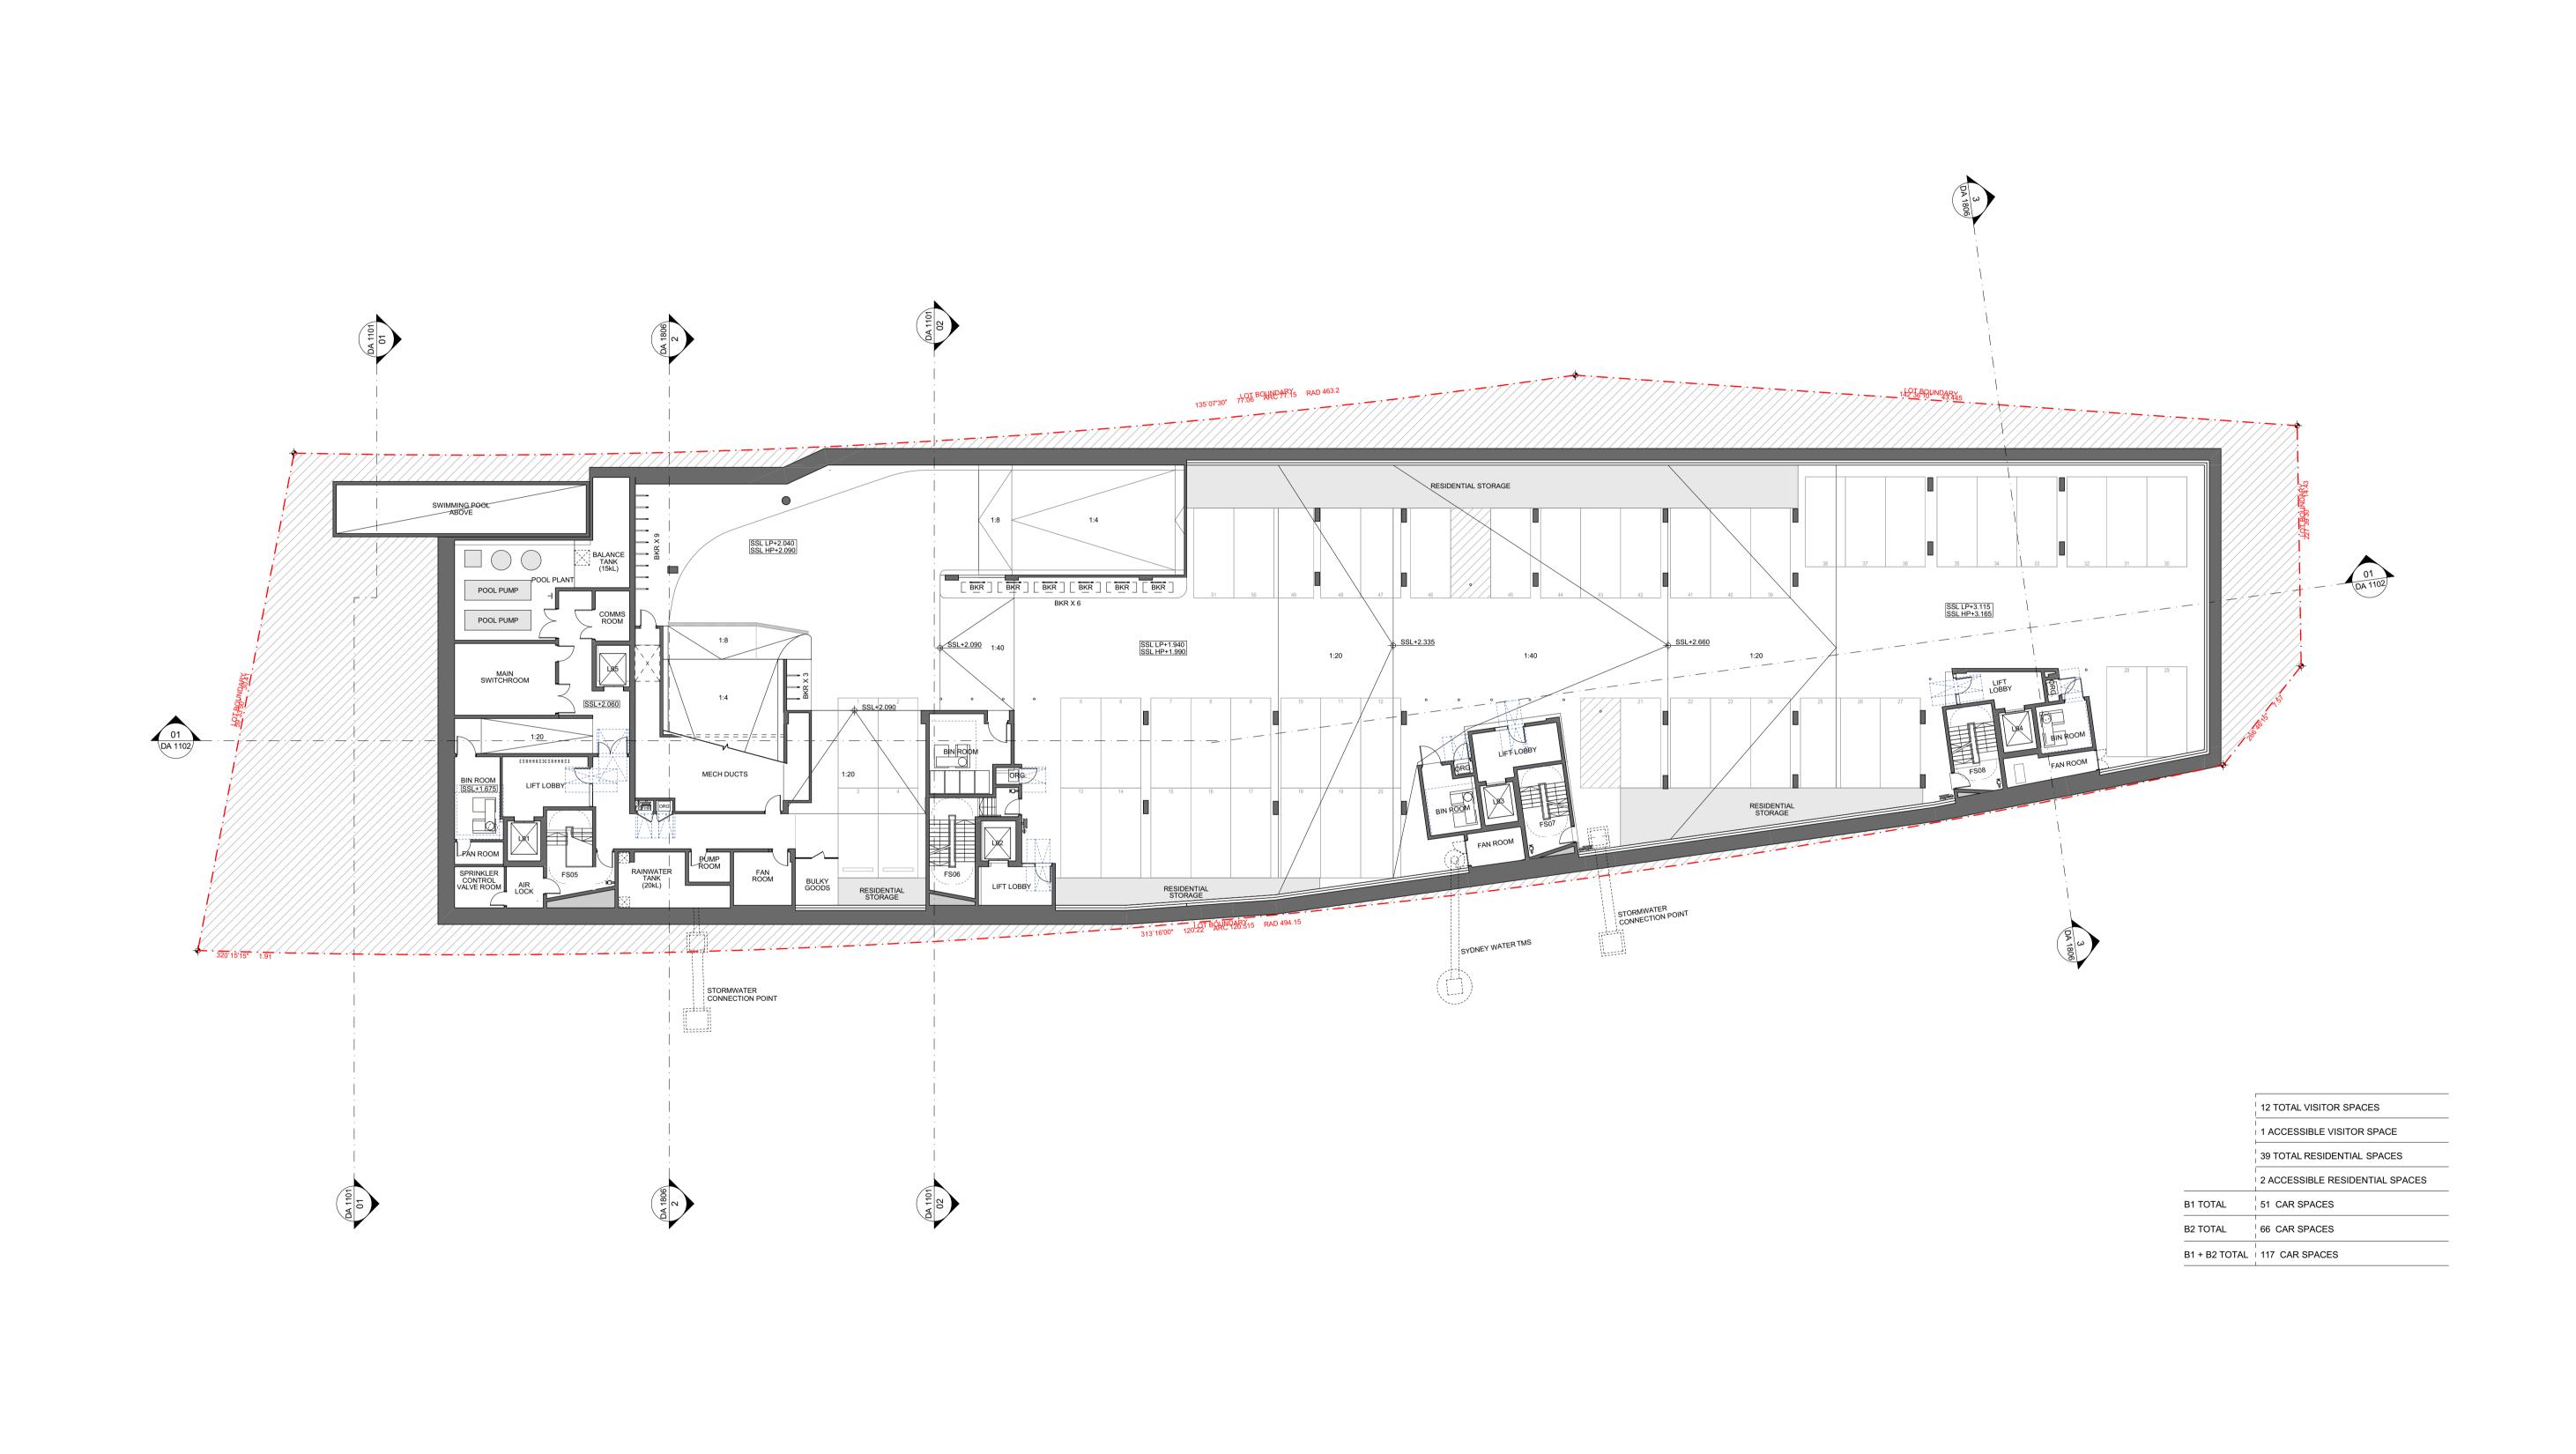
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Project: PRECINCT C	2 SHELL COVE			
Site: PRECINCT C	2 SHELL COVE			
Client: FRASERS PR	OPERTY PTY LIN	MITED		
Scale: 1:200 @ A1	Drawn By: MK / KM	Checked 1: KM	Checked 2: KM	Approved:

Candalepas Associates Registration No. NSW 5773
Registration No. VIC 17978
Registration No. WA 2405
Registration No. ACT 2603 Registration No. QLD 5463 309 Sussex Street, Sydney NSW 2000 info@candalepas.com.au T: 02 9283 7755 F: 02 9283 7477

NOT FOR CONSTRUCTION - DESIGN INTENT ONLY BASEMENT 2 PLAN 5965 Drawing Number: DA 1001



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PRECINCT C2 SHELL COVE

PRECINCT C2 SHELL COVE

Scale: 1:200 @ A1

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Drawn By: MK / KM

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Drawing:
BASEMENT 1 PLAN

Drawing Number:
DA 1002

Drawing Number:
C

DA 1002

Candalepas Associates


309 Sussex Street, Sydney NSW 2000

info@candalepas.com.au T: 02 9283 7755 F: 02 9283 7477

Registration No. NSW 5773 Registration No. VIC 17978 Registration No. WA 2405 Registration No. ACT 2603 Registration No. QLD 5463





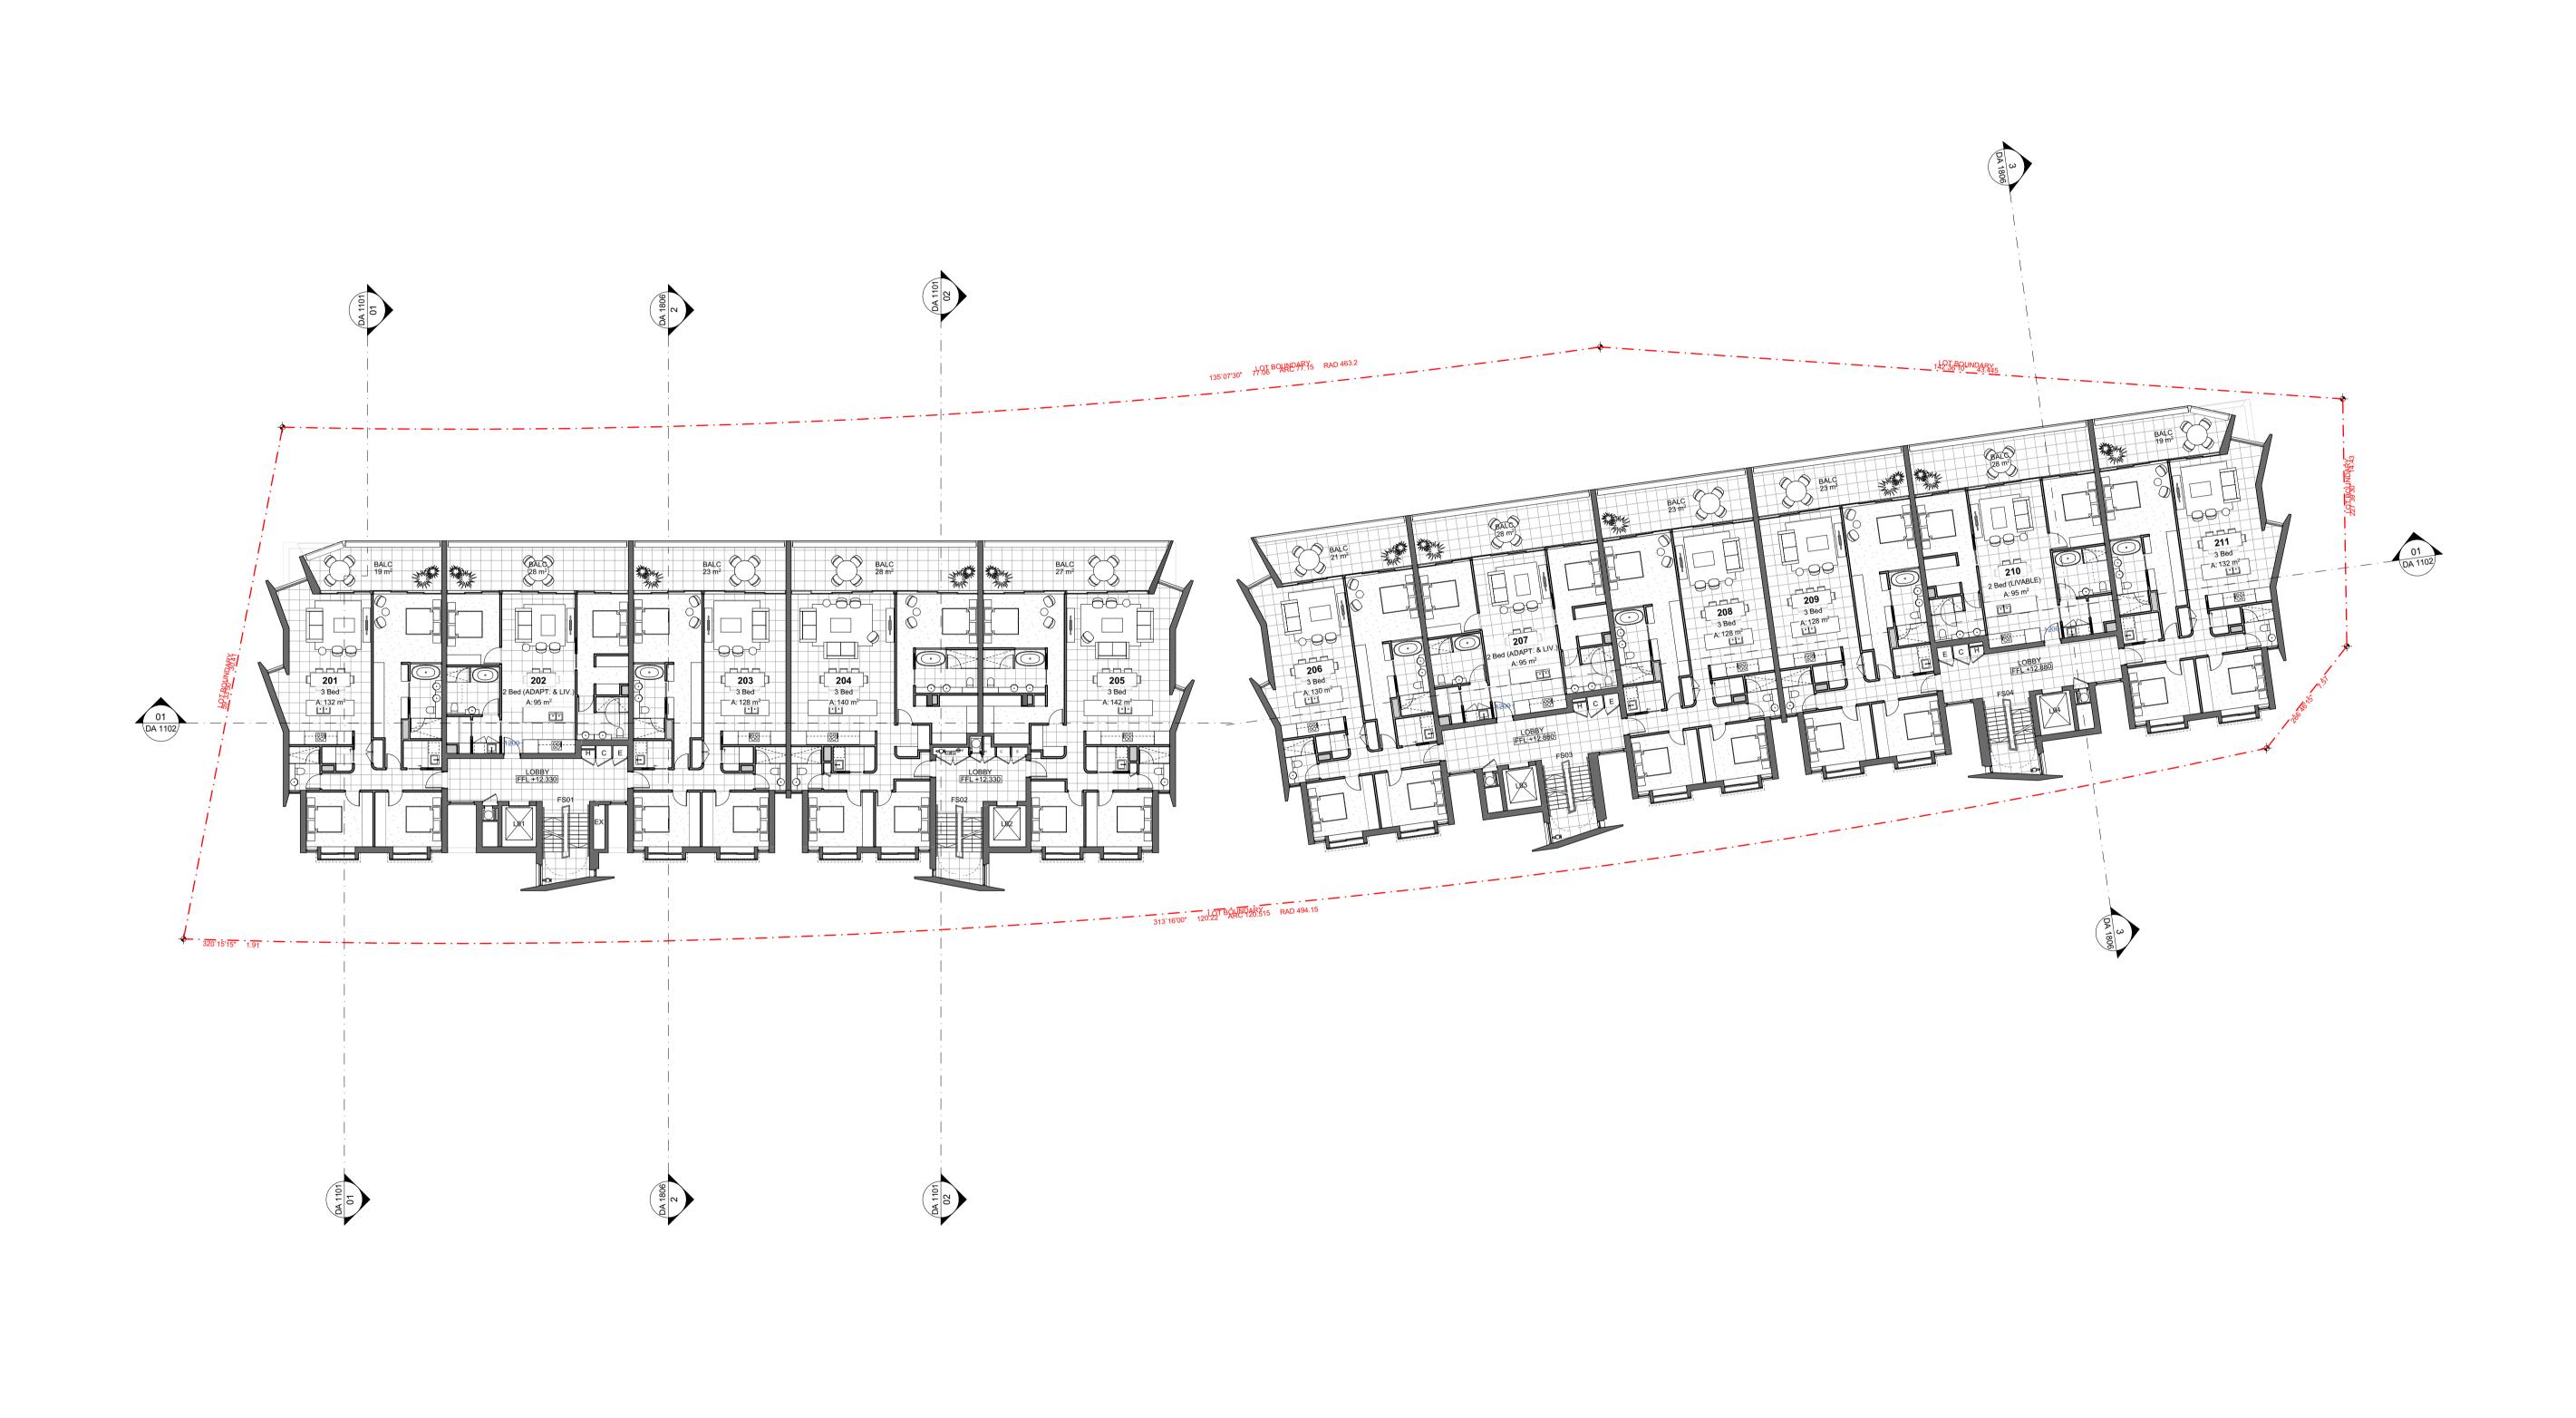

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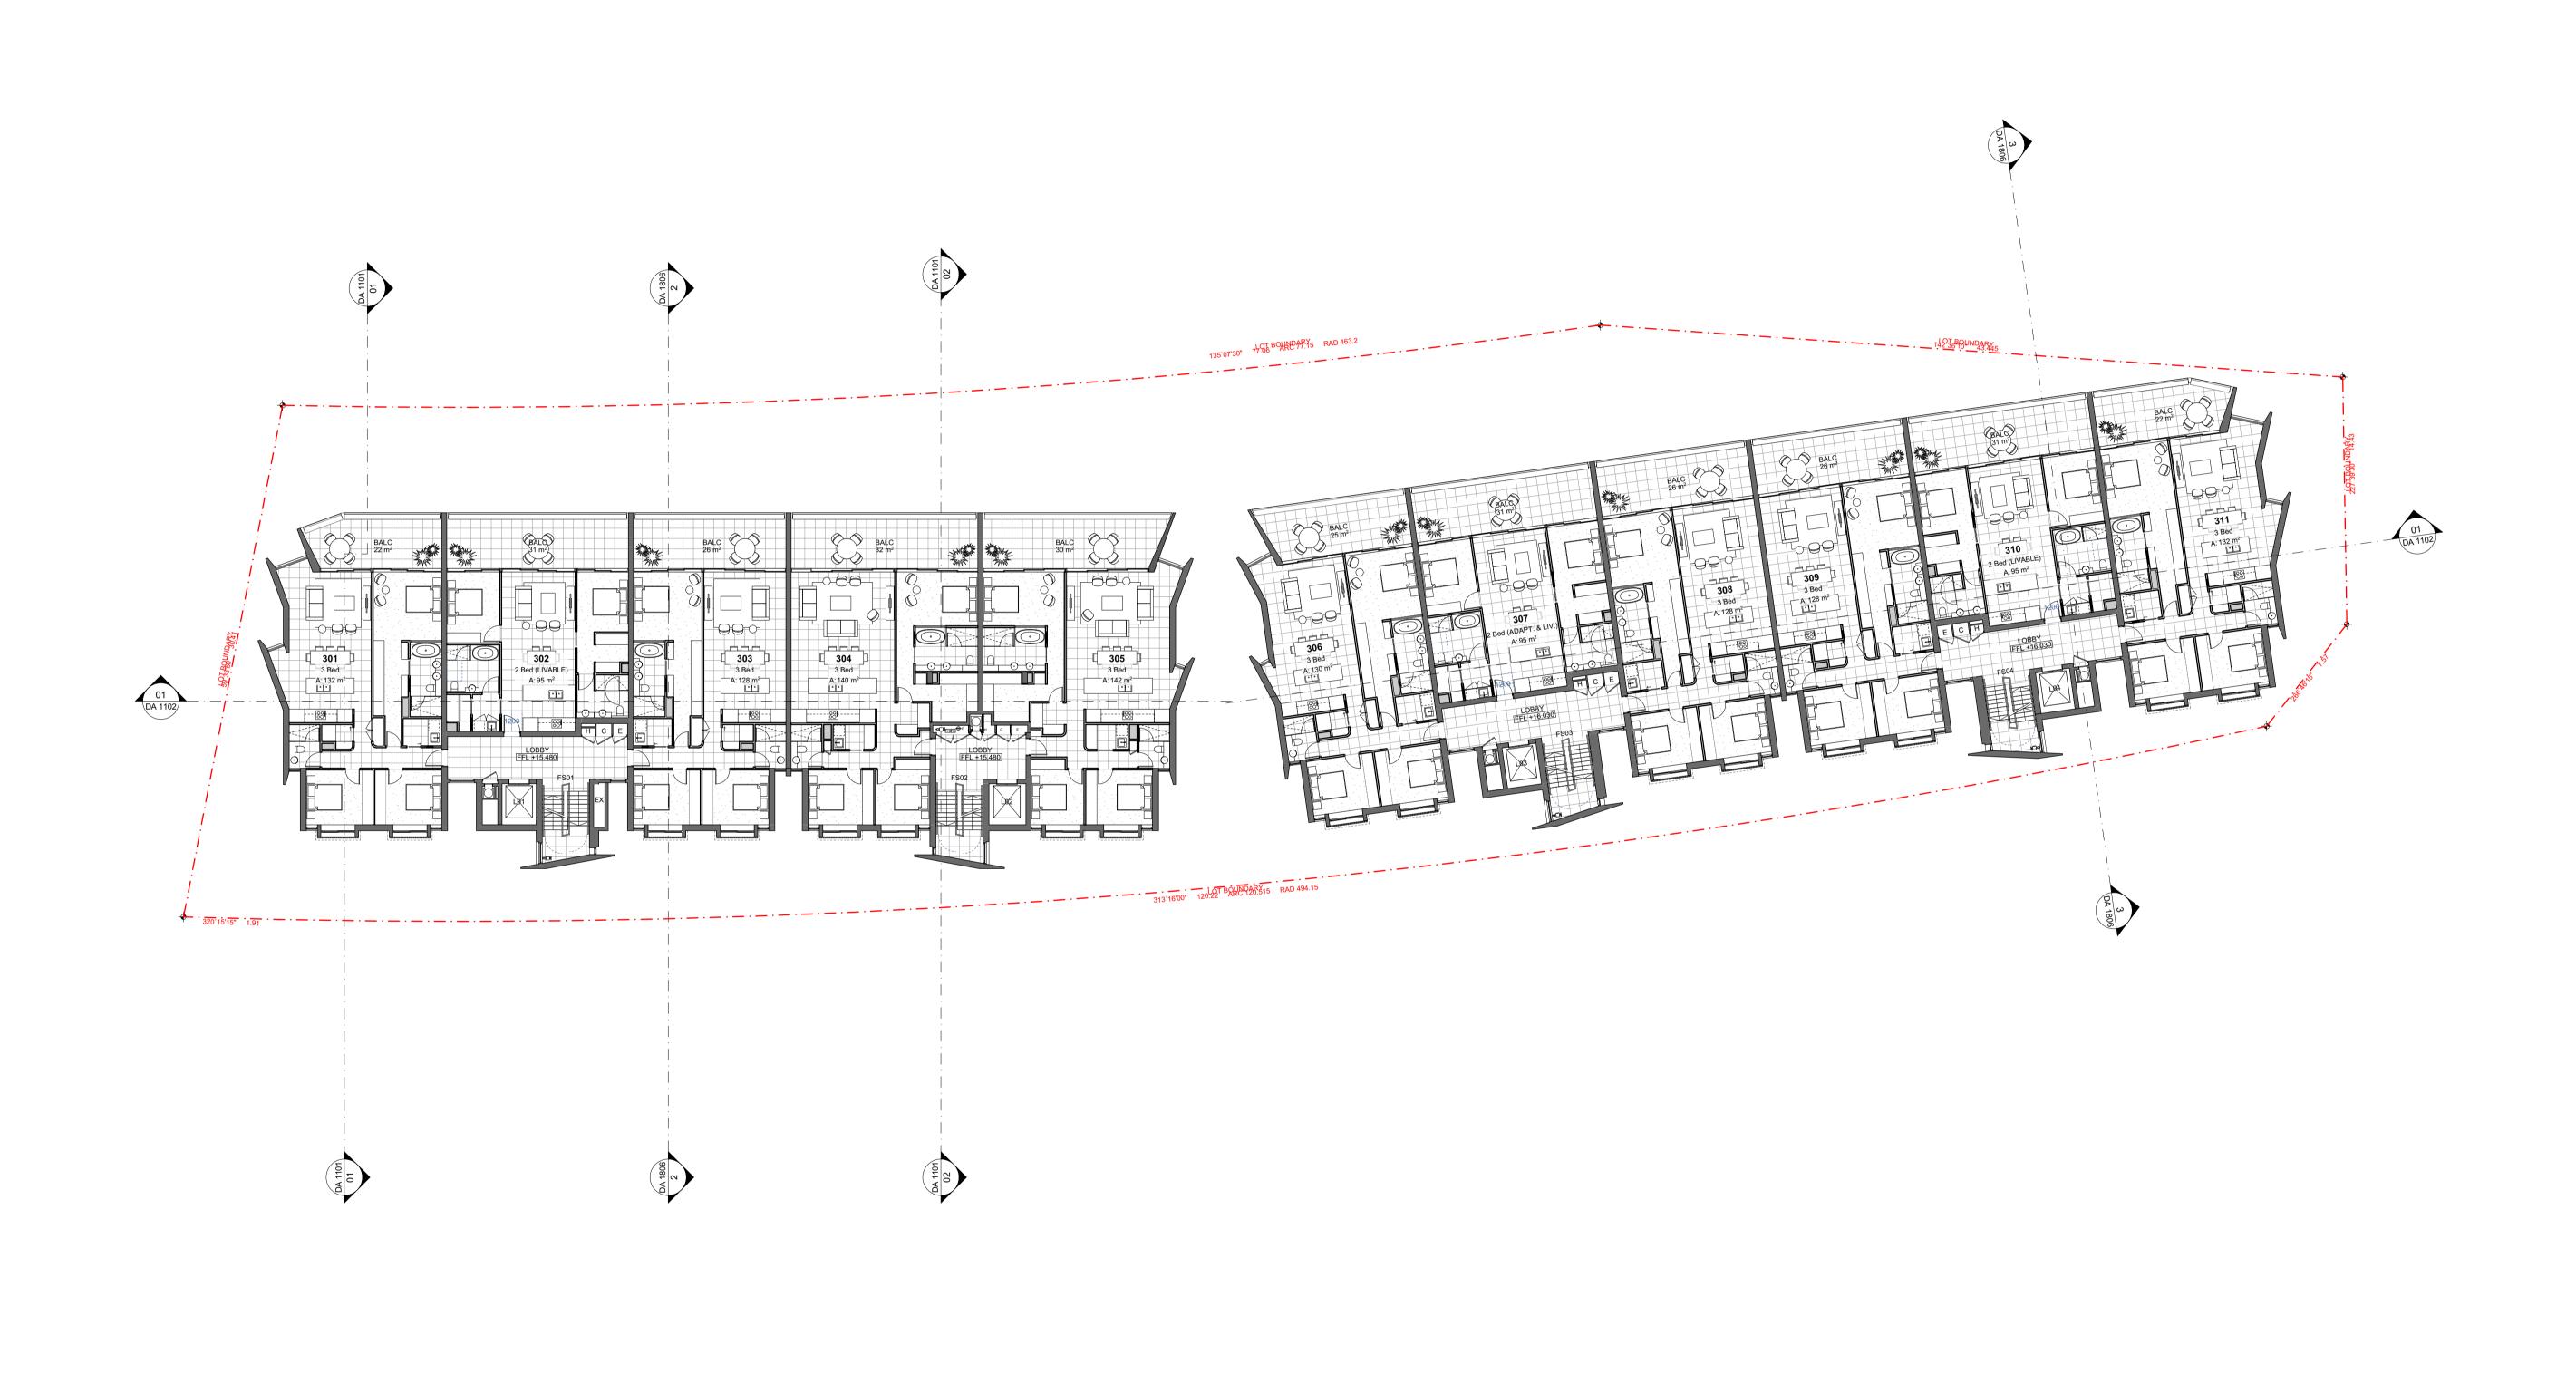
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Project: PRECINCT C2	SHELL COVE				Architect: Candalepas Associates
Site: PRECINCT C2 Client: FRASERS PRC	SHELL COVE	1ITED			Registration No. NSW 5773 Registration No. VIC 17978 Registration No. WA 2405 Registration No. ACT 2603 Registration No. QLD 5463 309 Sussex Street, Sydney NSW 2000
Scale: 1:200 @ A1	Drawn By: BF	Checked 1: BF	Checked 2: PK	Approved: AC	info@candalepas.com.au T: 02 9283 7755 F: 02 9283 7477

NOT FOR CONSTRUCTION - DESIGN INTENT ONLY Candalepas Associates LEVEL 2 PLAN 5965 Registration No. NSW 5773 Registration No. VIC 17978 Registration No. WA 2405 Registration No. ACT 2603 Registration No. QLD 5463 Drawing Number: DA 1005 309 Sussex Street, Sydney NSW 2000 info@candalepas.com.au



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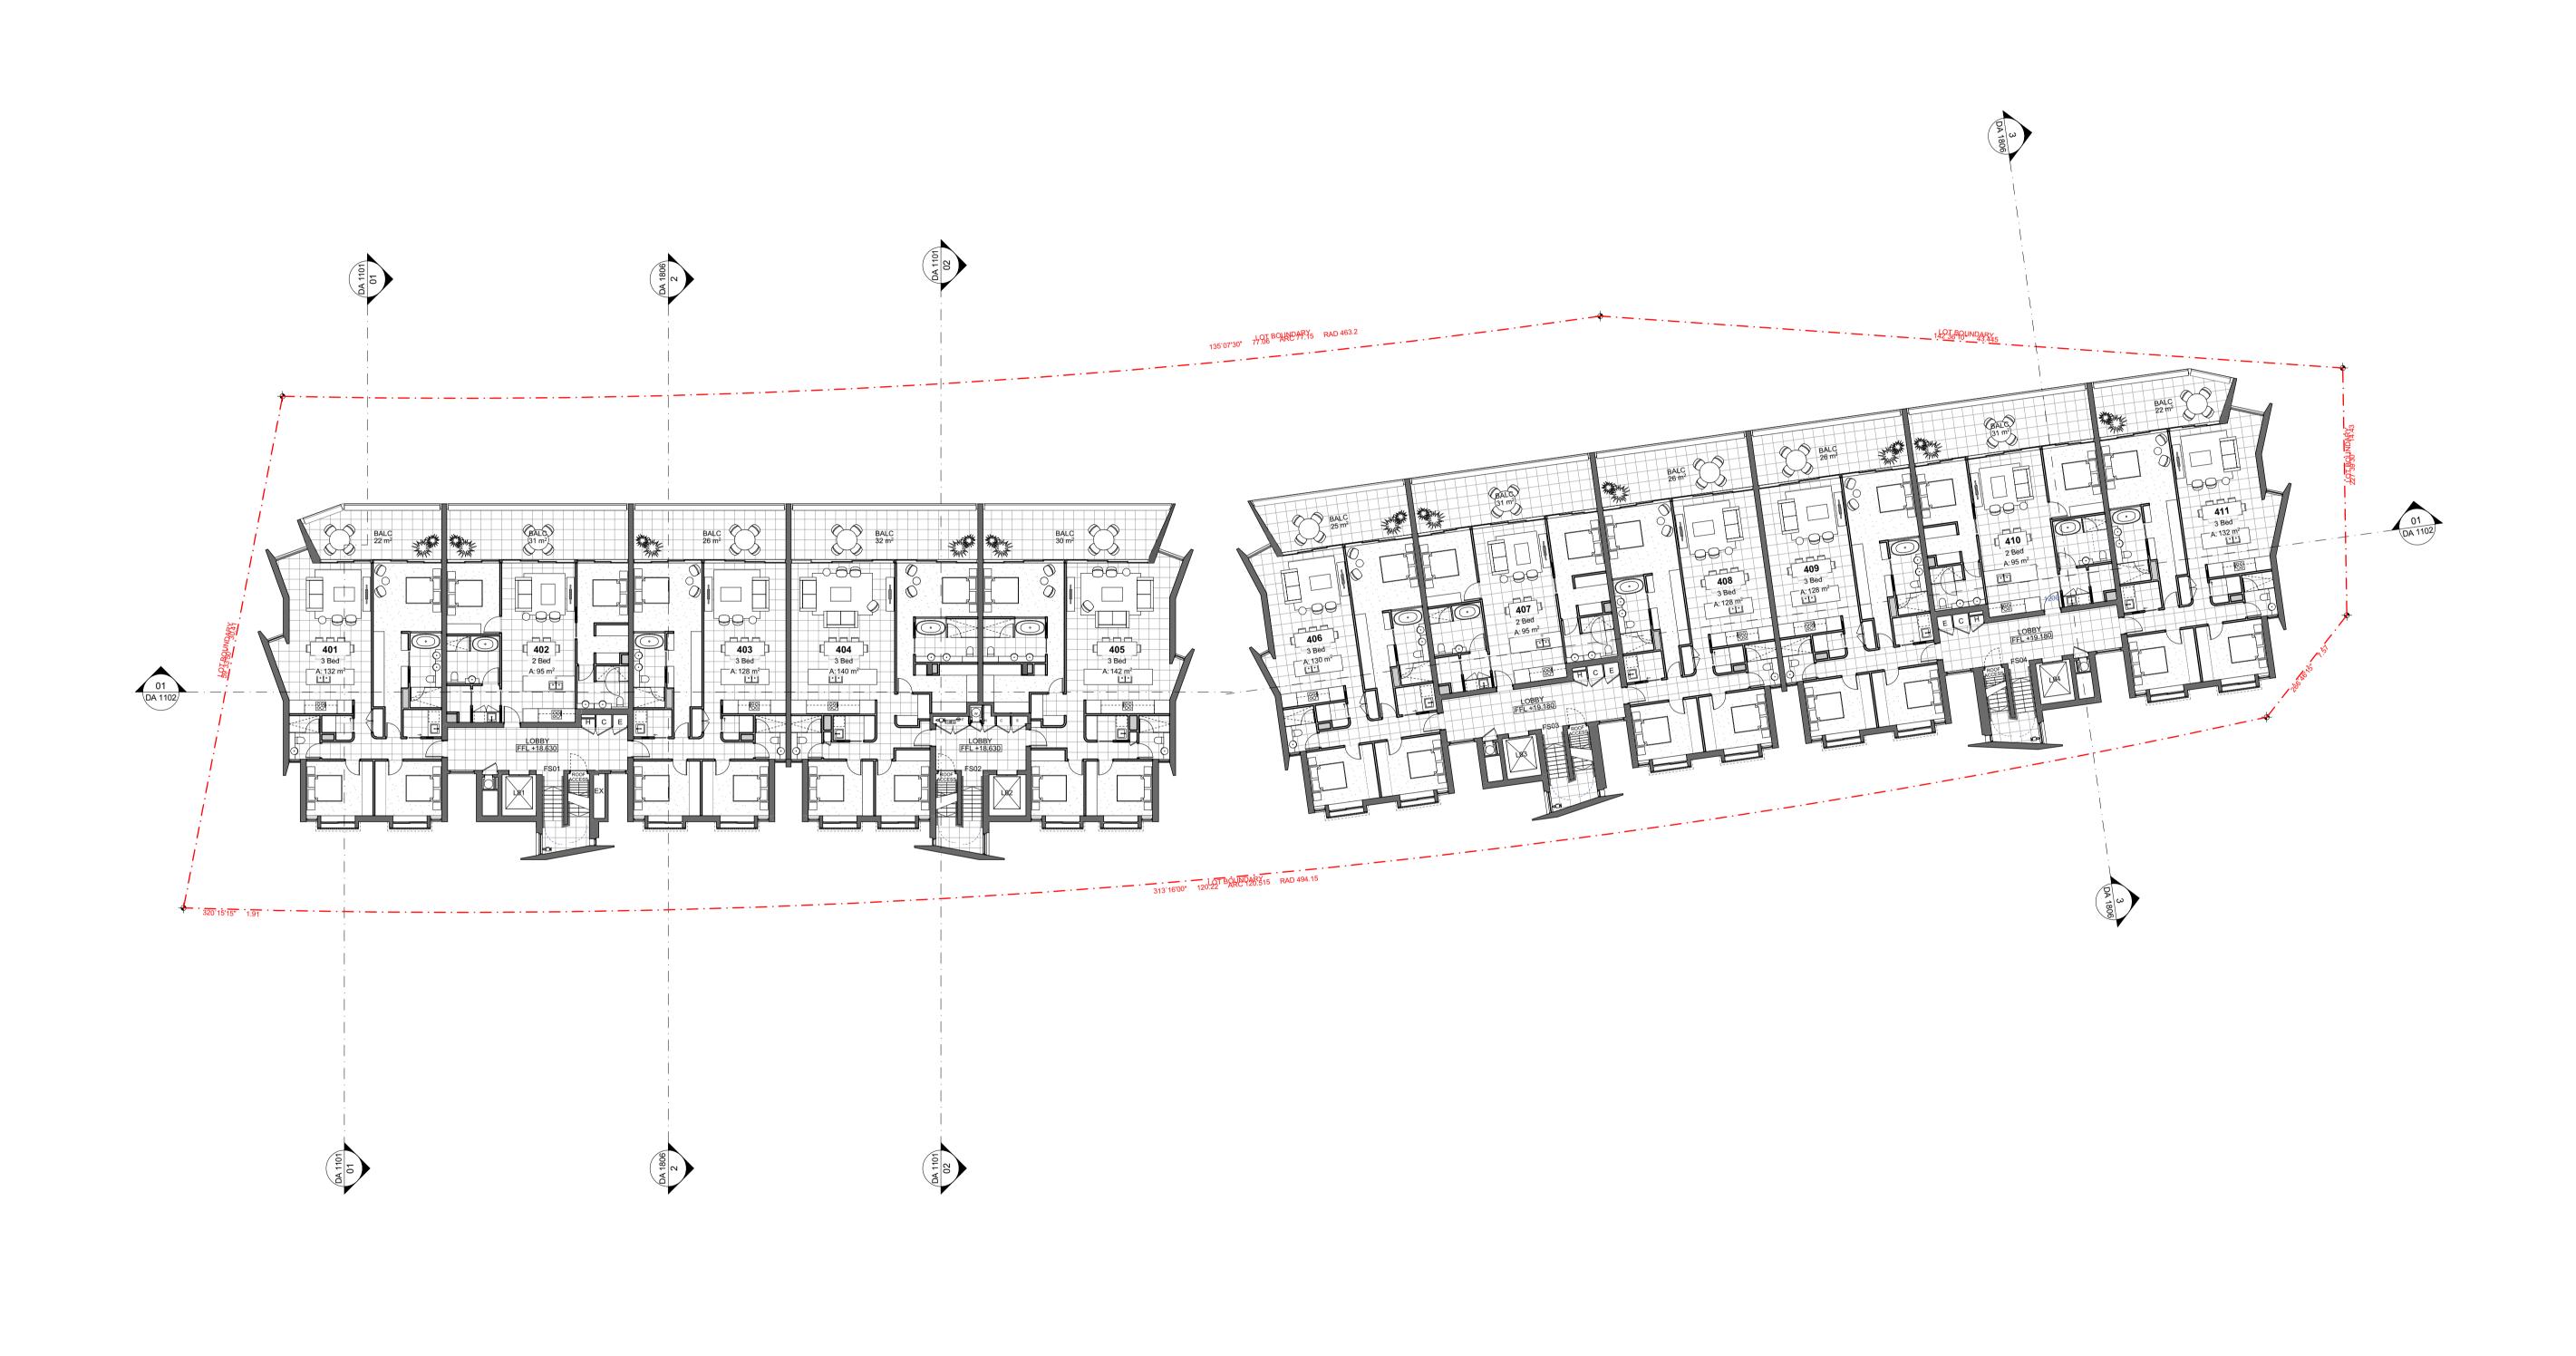
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Project:				
PRECINCT	C2 SHELL COVE			
Site:				
PRECINCT	C2 SHELL COVE			
Client:				
FRASERS P	ROPERTY PTY LIN	MITED		
Scale:	Drawn By:	Checked 1:	Checked 2:	Approved:
1:200 @ A1	BF	BF	PK	AC

Architect:
Candalepas Associates
Registration No. NSW 5773
Registration No. NC 17978
Registration No. ACT 2603
Registration No. QLD 5463
309 Sussex Street, Sydney NSW 2000
info@candalepas.com.au
T: 02 9283 7755 F: 02 9283 7477



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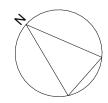
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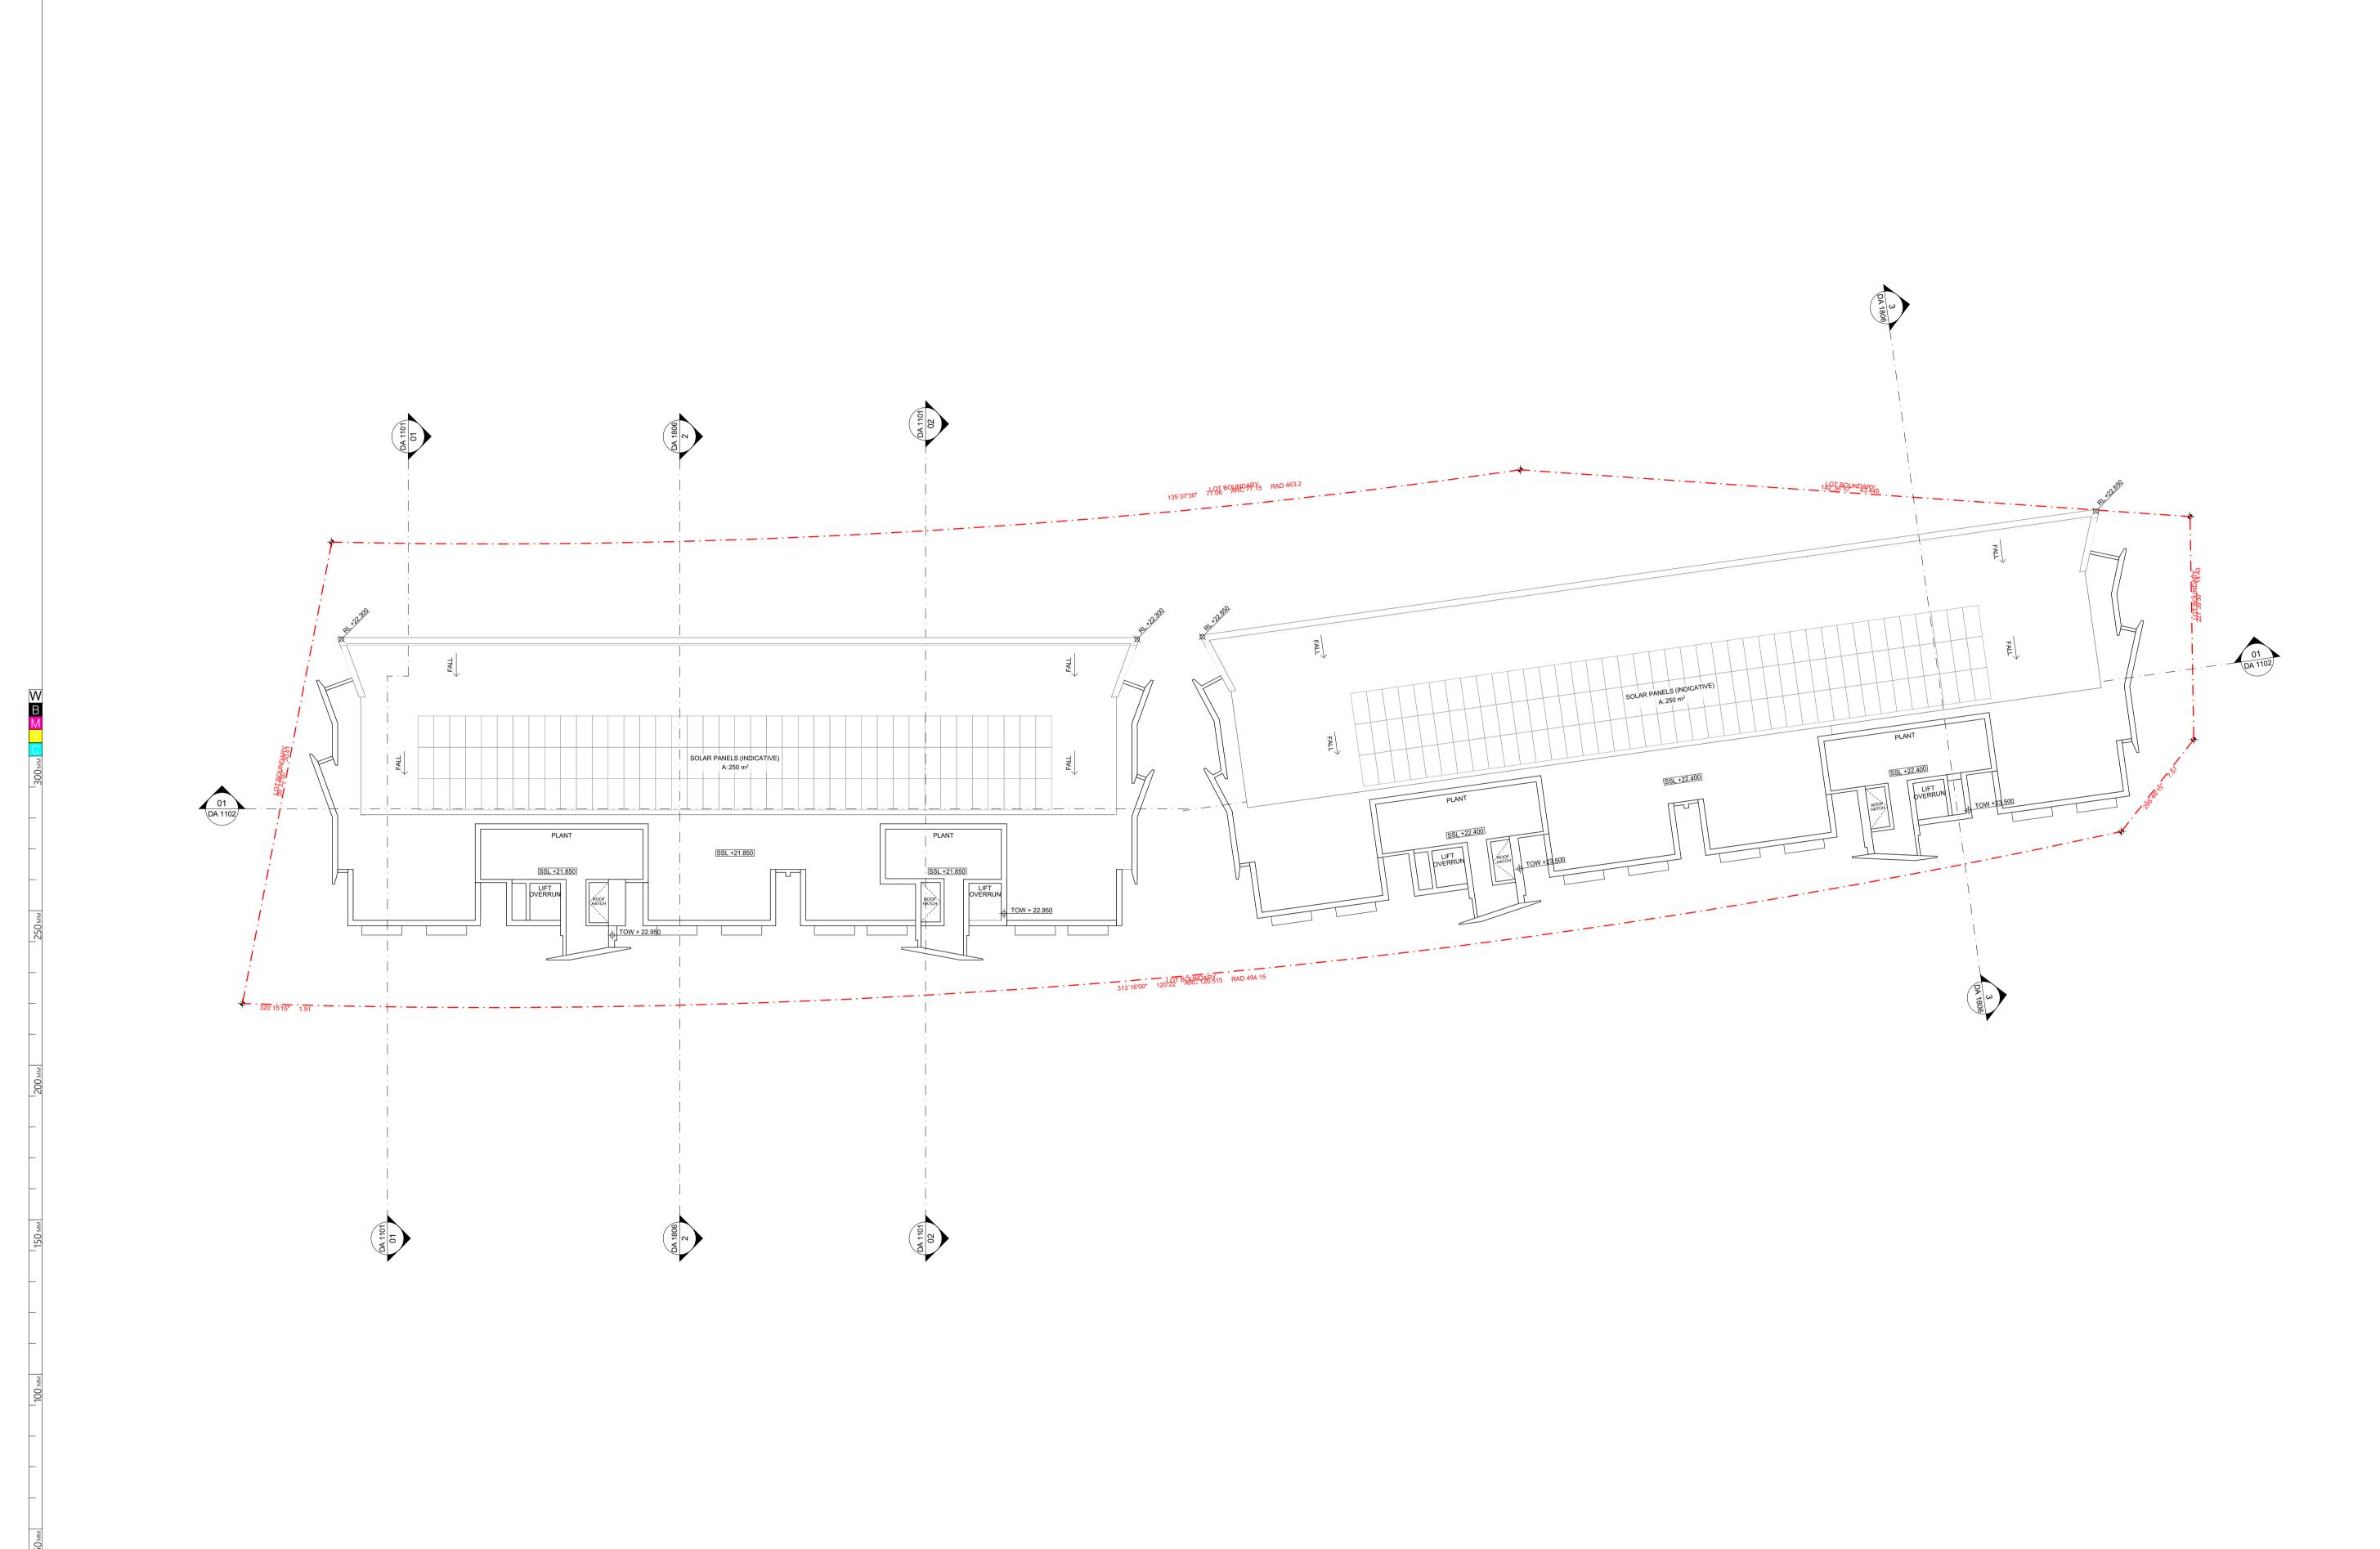
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	Project: PRECINCT C2 S	SHELL COVE				Architect: Candalepas Associates
\	Site: PRECINCT C2 S	SHELL COVE				Registration No. NSW 5773 Registration No. VIC 17978 Registration No. WA 2405
7	Client: FRASERS PROP	ERTY PTY LIMITE	ED			Registration No. ACT 2603 Registration No. QLD 5463 309 Sussex Street, Sydney NSW 2000
	Scale: 1:200 @ A1	Drawn By: BF	Checked 1: BF	Checked 2: PK	Approved: AC	info@candalepas.com.au T: 02 9283 7755 F: 02 9283 7477

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alepas Associates stion No. NSW 5773 stion No. VIC 17978 stion No. WA 2405	LEVEL 4 PLAN	5965
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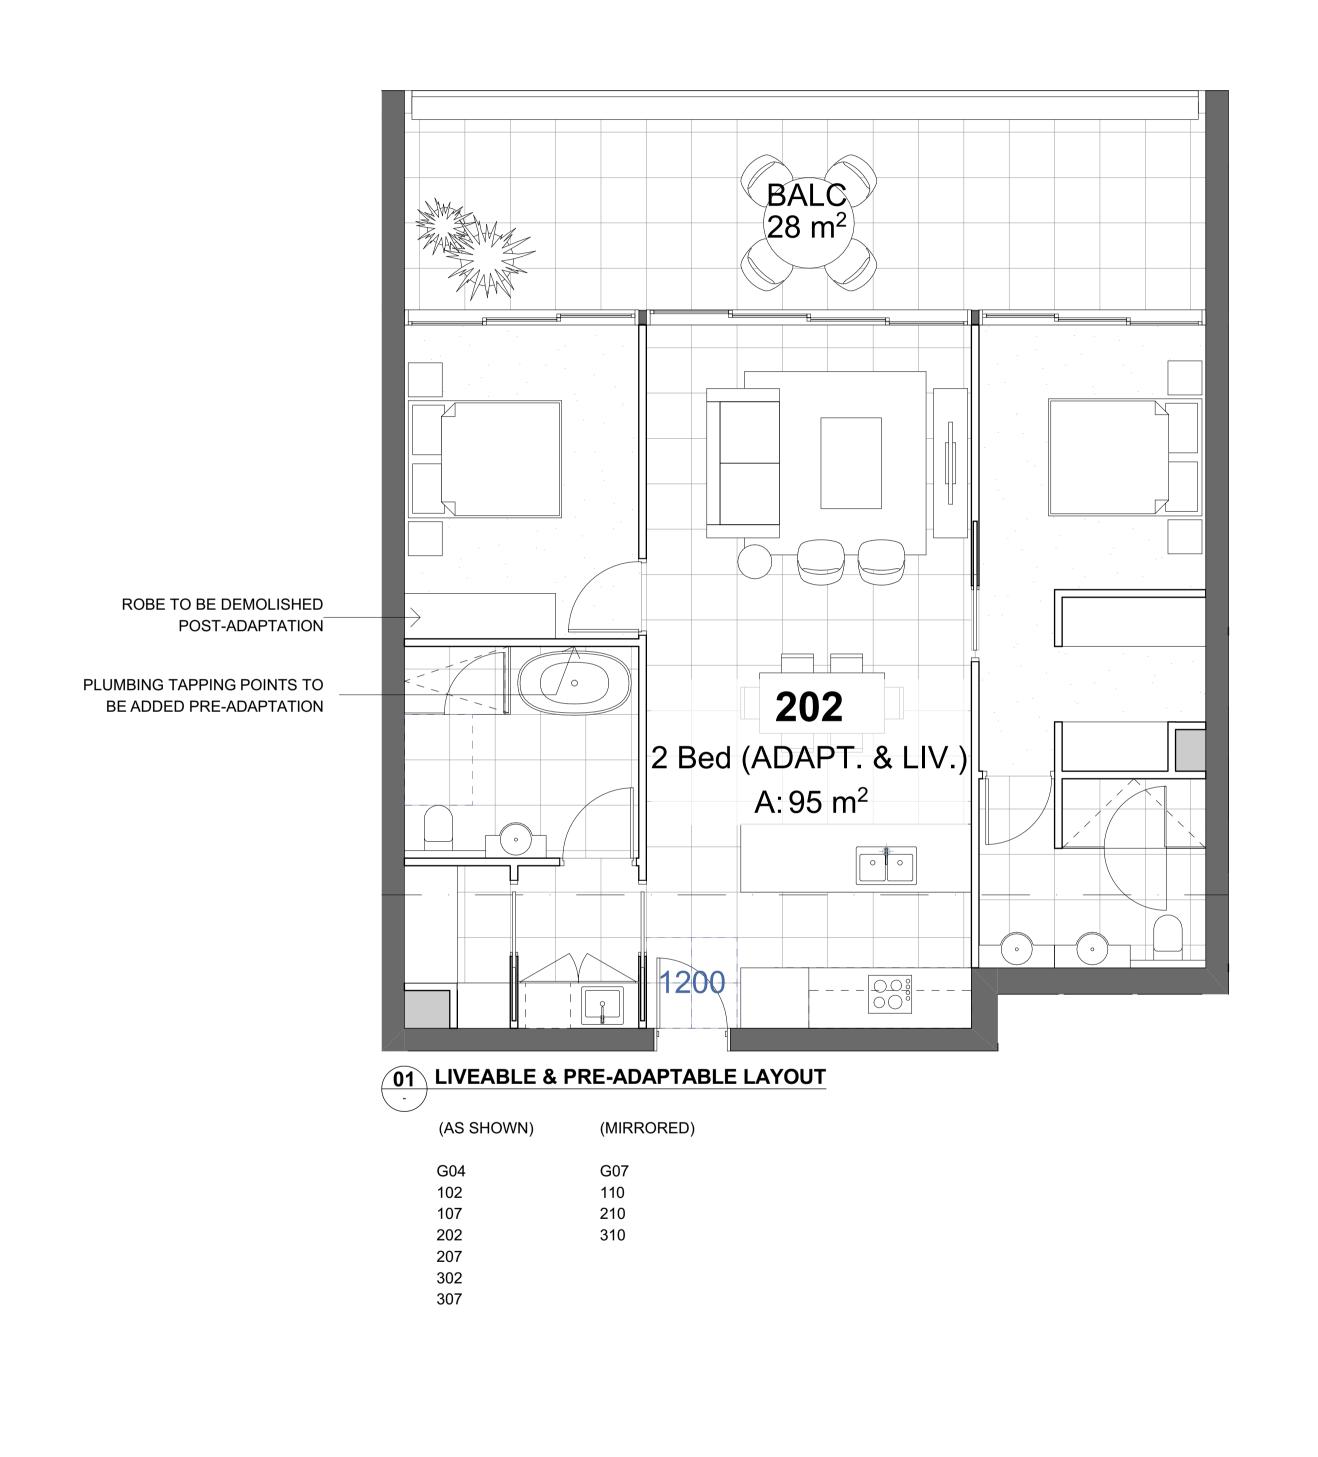
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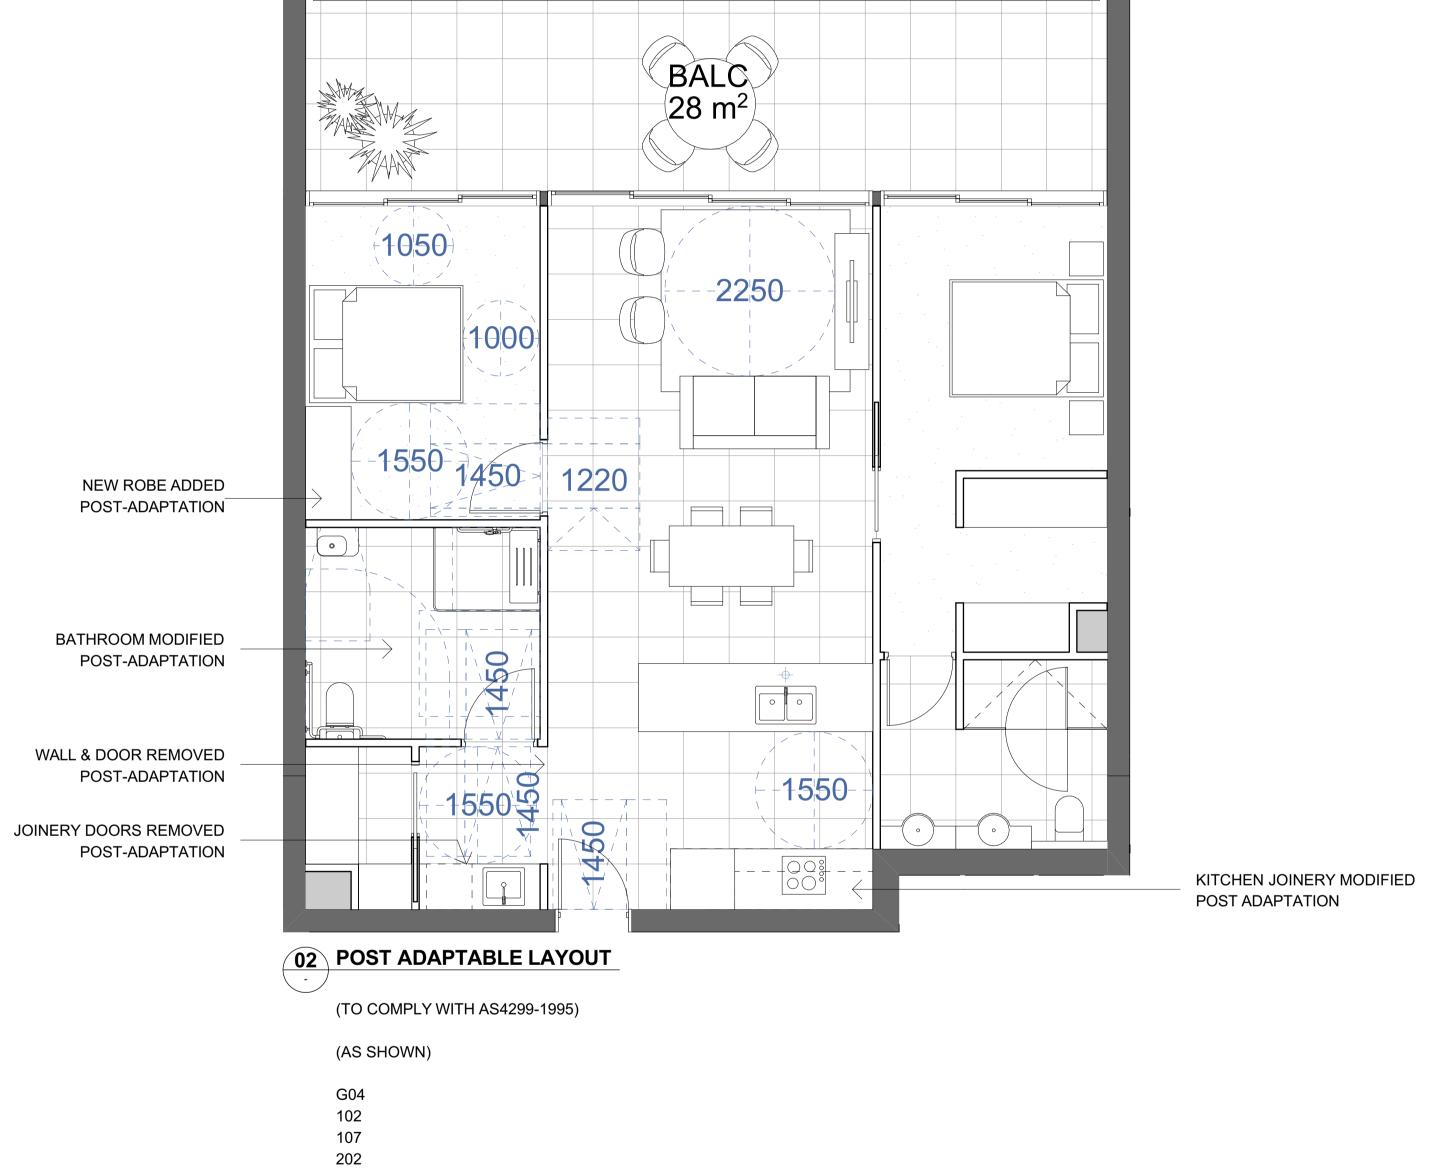
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Project:					
PRECINCT C2	SHELL COVE				
Site: PRECINCT C2	SHELL COVE				
Client: FRASERS PRC	PERTY PTY LIN	MITED			
Scale: 1:200 @ A1	Drawn By: BF	Checked 1: BF	Checked 2: PK	Approved: AC	

NOT FOR CONSTRUCTION - DESIGN INTENT ONLY Candalepas Associates **ROOF PLAN** 5965 Registration No. NSW 5773 Registration No. VIC 17978 Registration No. WA 2405 Registration No. ACT 2603 Registration No. QLD 5463 Drawing Number: DA 1008 09 Sussex Street, Sydney NSW 2000 nfo@candalepas.com.au F: 02 9283 7755 F: 02 9283 7477





207 307

> TOTAL: 6 ADAPTABLE UNITS (11% TOTAL NUMBER OF UNITS)

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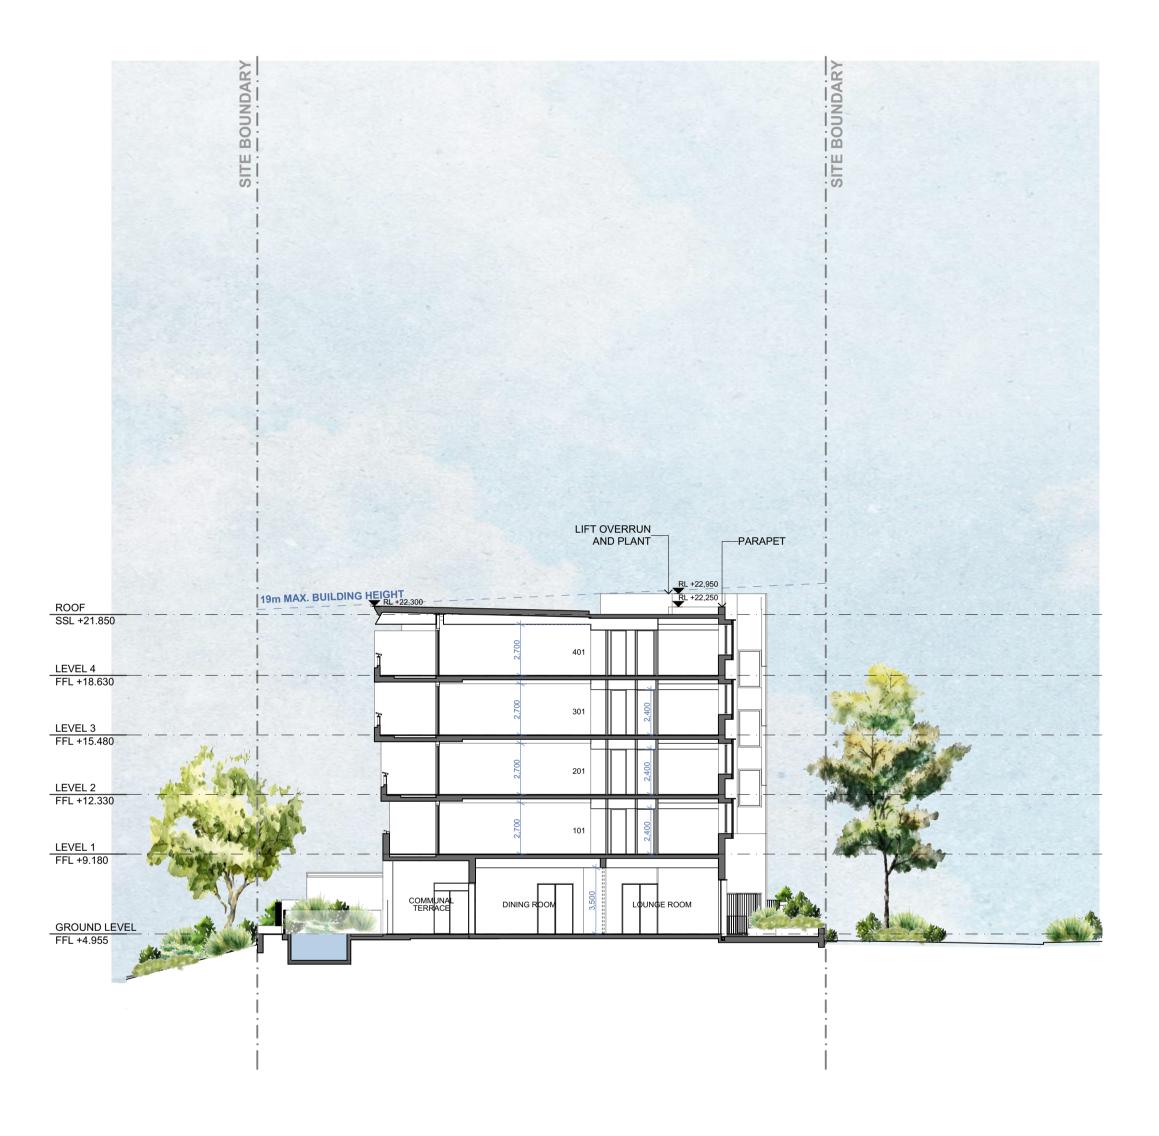
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PRECINCT C2 SHELL COVE PRECINCT C2 SHELL COVE FRASERS PROPERTY PTY LIMITED 309 Sussex Street, Sydney NSW 2000 Scale: 1:50 @ A1 info@candalepas.com.au T: 02 9283 7755 F: 02 9283 7477

Candalepas Associates UNIVERSAL DESIGN Registration No. NSW 5773 Registration No. VIC 17978 Registration No. WA 2405 Registration No. ACT 2603 Drawing Number: Registration No. QLD 5463

NOT FOR CONSTRUCTION - DESIGN INTENT ONLY 5965 DA 1051



LIFT OVERRUN_ AND PLANT 19m MAX. BUILDING HEIGHT ROOF SSL +21.850 LEVEL 4 FFL +18.630

O1 SECTION A

- Scale 1:200

02 SECTION B - Scale 1:200

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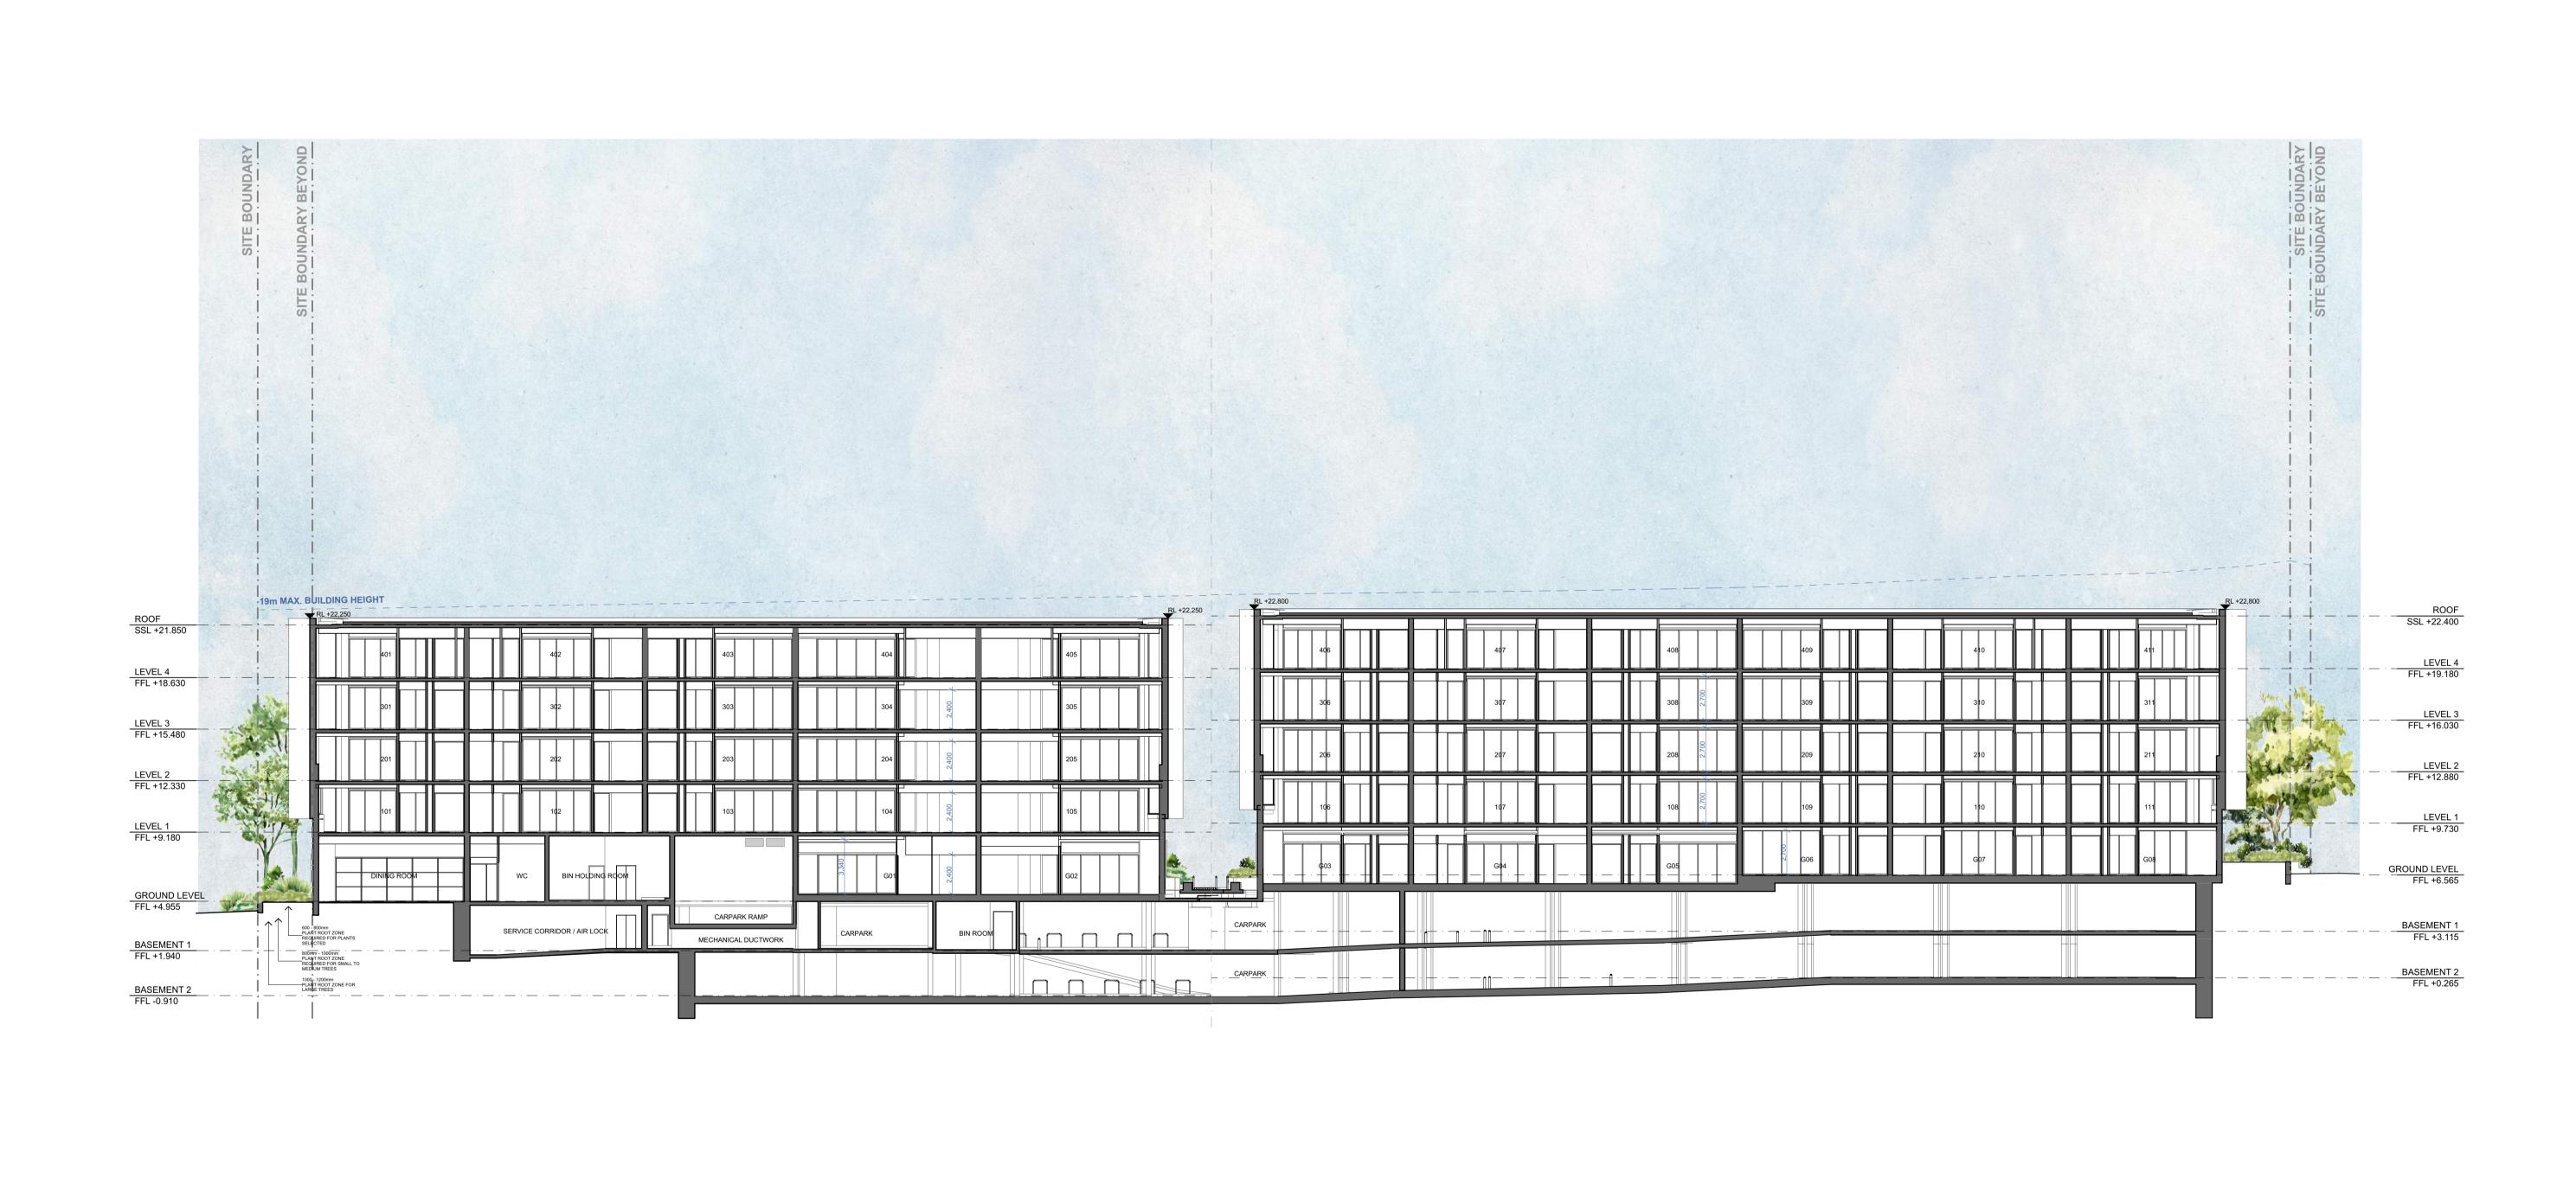
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	Project:					Architect:		
	PRECINCT C2 S	SHELL COVE				Candalep Registration N		
	Site: PRECINCT C2 SHELL COVE							
	Client: FRASERS PROPERTY PTY LIMITED							
	Scale: 1:200 @ A1	Drawn By: JMT	Checked 1: JMT	Checked 2: PK	Approved: AC	info@candale T: 02 9283 77!		

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o. NSW 5773		3303
o. VIC 17978 o. WA 2405		
b. ACT 2603		
o. QLD 5463	Drawing Number:	Issue:
eet, Sydney NSW 2000	DA 1101	C
as.com.au		
5 F: 02 9283 7477		



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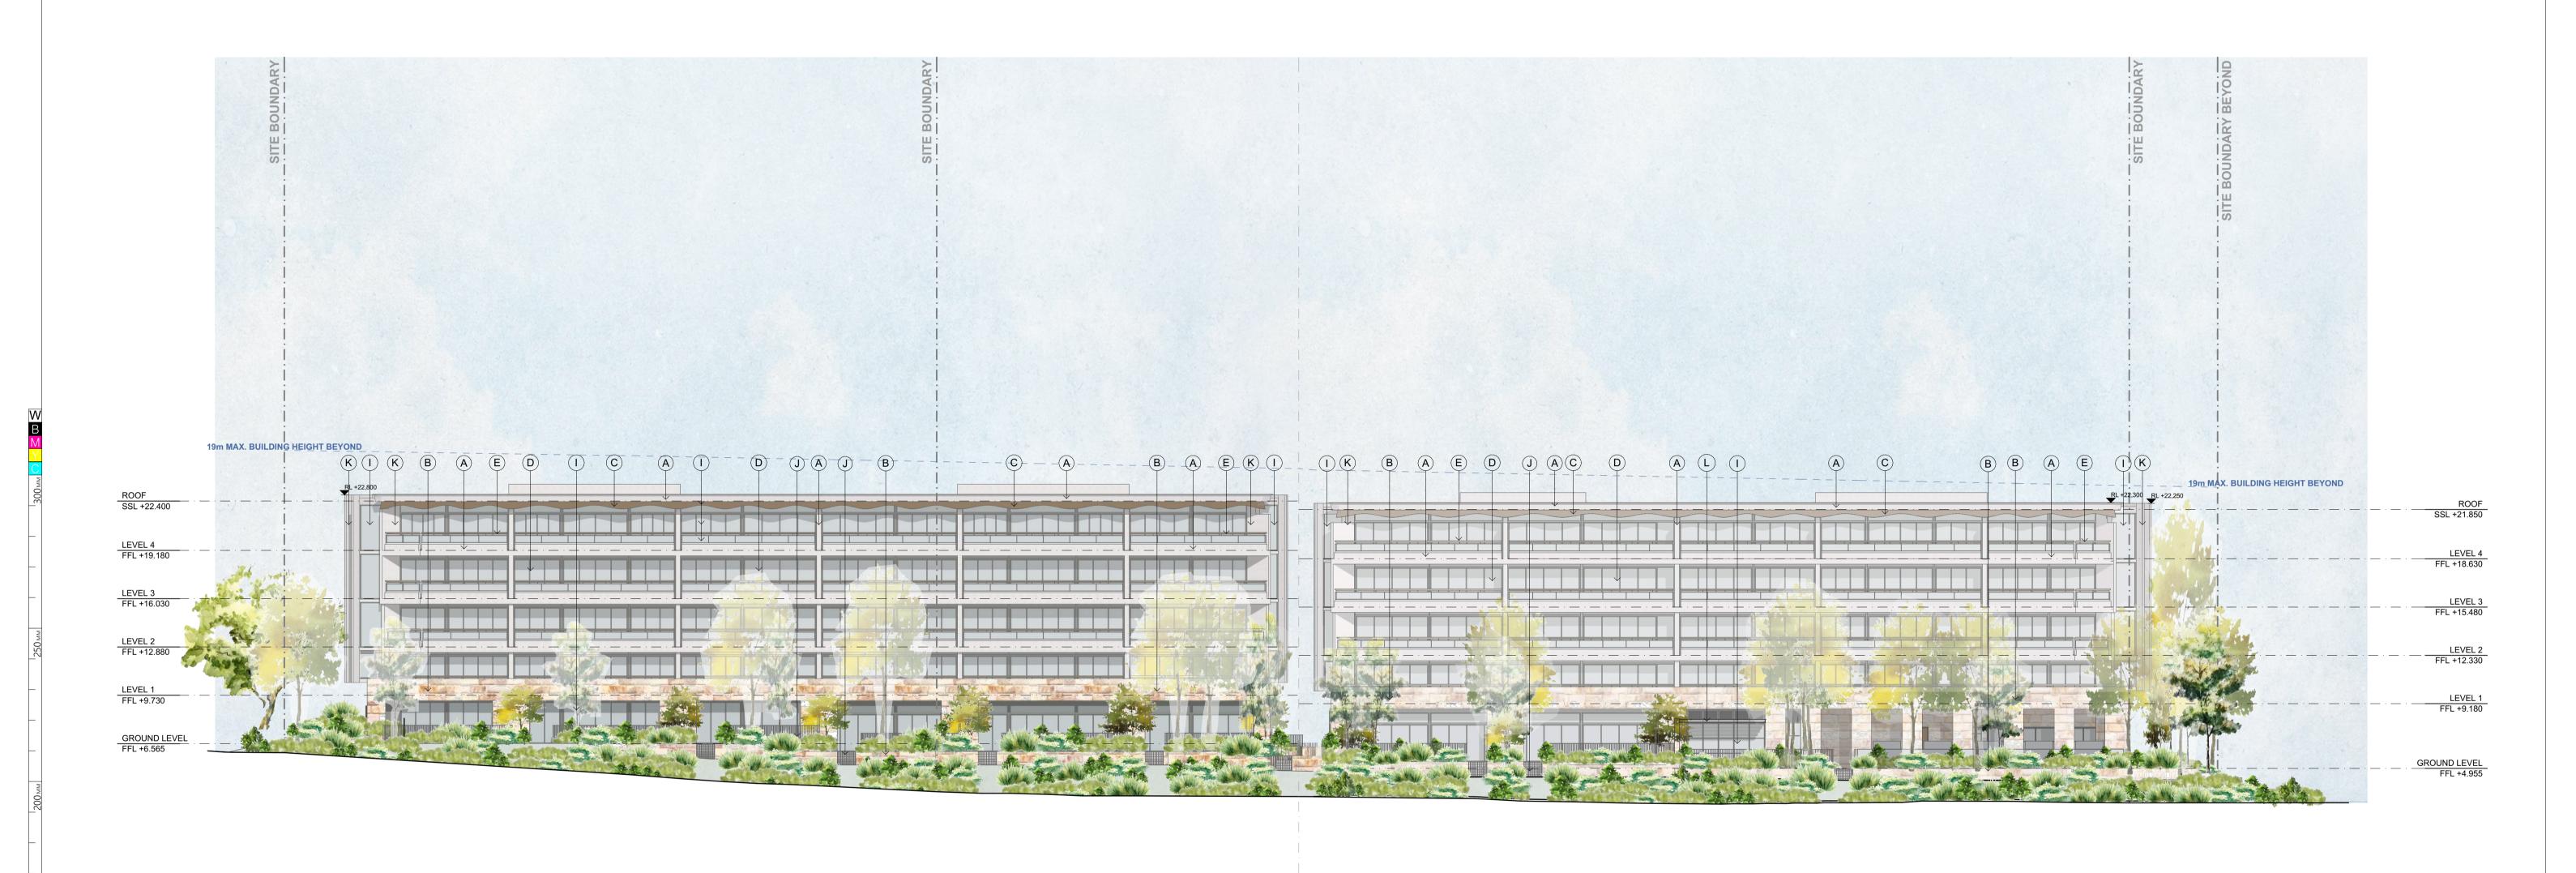
Project:
PRECINCT C2 SHELL COVE

Site:
PRECINCT C2 SHELL COVE

Client:
FRASERS PROPERTY PTY LIMITED

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Architect:
Candalepas Associates
Registration No. NSW 5773
Registration No. VIC 17978
Registration No. WA 2405
Registration No. QLD 5463
309 Sussex Street, Sydney NSW 2000
info@candalepas.com.au
T: 02 9283 7755 F: 02 9283 7477















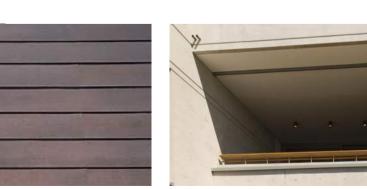

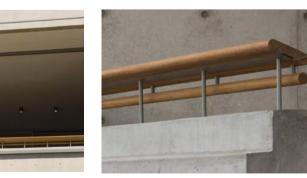



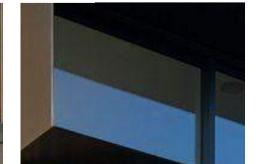

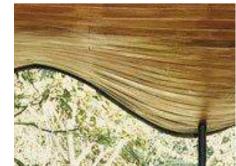







K - PRECAST CONCRETE



A - OFF-FORM INSITU CONCRETE

B - SANDSTONE (FINISH VARIOUS)

C - COPPER CLADDING

D - BALCONY

E - TIMBER HANDRAILS

SCREENING

G - BRONZE COLOURED METAL WINDOW F - POWDERCOATED METAL SHROUDS

H - INTERNAL TIMBER CEILING LINING

I - CLEAR GLASS

J - METAL PALISADE FENCE

L - SHADING PERGOLA

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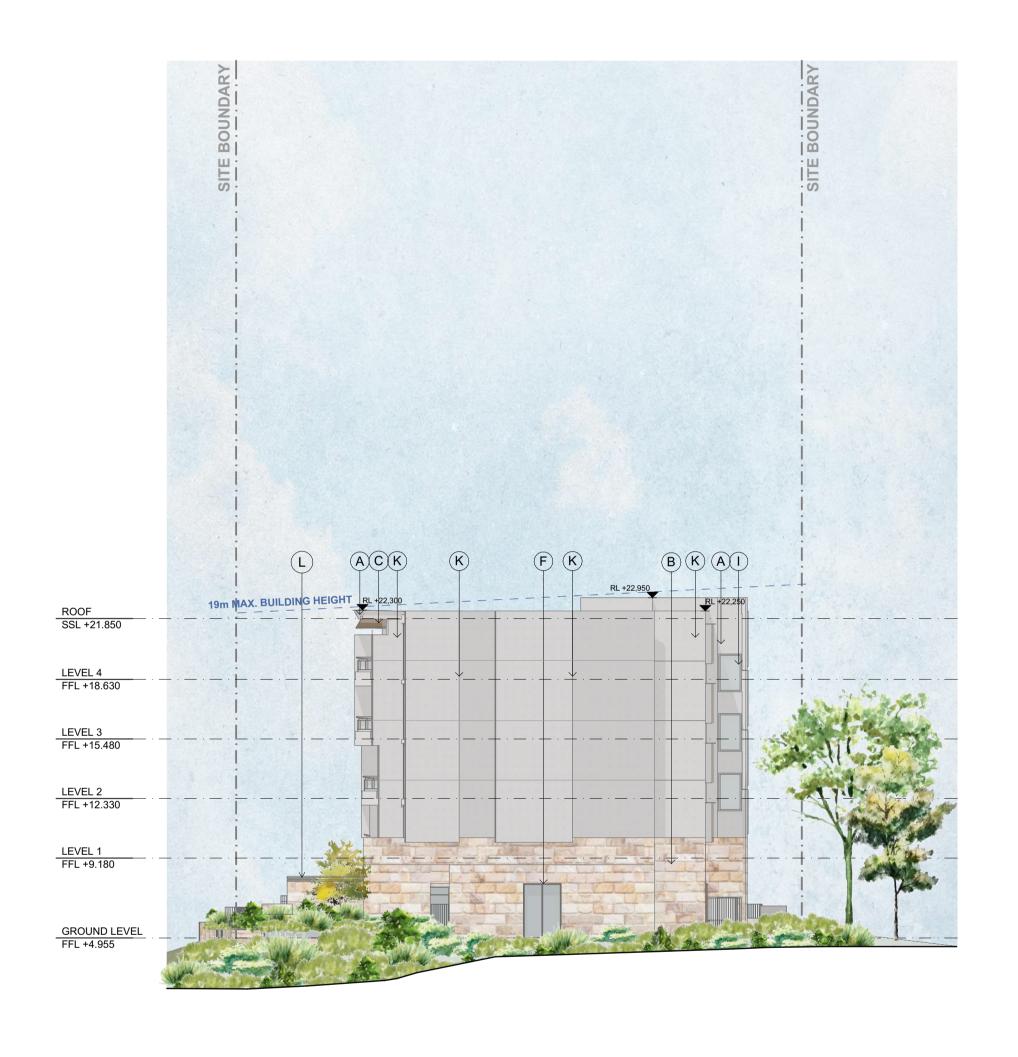
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PRECINCT C2 SHELL COVE PRECINCT C2 SHELL COVE FRASERS PROPERTY PTY LIMITED 1:200 @ A1

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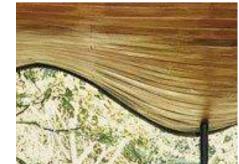




















C - COPPER CLADDING

E - TIMBER HANDRAILS

SCREENING

G - BRONZE COLOURED METAL WINDOW F - POWDERCOATED METAL SHROUDS





5965

A - OFF-FORM INSITU CONCRETE

B - SANDSTONE (FINISH VARIOUS)

D - BALCONY

H - INTERNAL TIMBER CEILING LINING

I - CLEAR GLASS

J - METAL PALISADE FENCE

K - PRECAST CONCRETE



L - SHADING PERGOLA

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PRECINCT C2 SHELL COVE							
Site:	Site:						
PRECINCT C2 S	PRECINCT C2 SHELL COVE						
Client:							
FRASERS PROPERTY PTY LIMITED							
Scale:	Drawn By:	Checked 1:	Checked 2:	Approved:			
1:200 @ A1	MK / KM	KM	KM	AC			

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Architect:		Drawing:	Job Nur
Candalepas Associates		NORTH & SOUTH ELEVATION	596
Registration No. NSW 5773 Registration No. VIC 17978 Registration No. WA 2405			
Registration No. ACT 2603 Registration No. QLD 5463		Drawing Number:	Issue:
109 Sussex Street, Sydney NSW 2000 nfo@candalepas.com.au 1: 02 9283 7755 F: 02 9283 7477		DA 1202	С



01 WEST ELEVATION














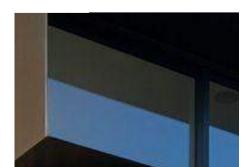











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B - SANDSTONE (FINISH VARIOUS)

C - COPPER CLADDING

D - BALCONY

E - TIMBER HANDRAILS

SCREENING

G - BRONZE COLOURED METAL WINDOW F - POWDERCOATED METAL SHROUDS

H - INTERNAL TIMBER CEILING LINING

I - CLEAR GLASS

J - METAL PALISADE FENCE

K - PRECAST CONCRETE

L - POWDERCOATED ALUMINIUM PANEL LIFT GARAGE DOOR

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PRECINCT C2 SHELL COVE PRECINCT C2 SHELL COVE FRASERS PROPERTY PTY LIMITED Scale: 1:200 @ A1 MK / KM

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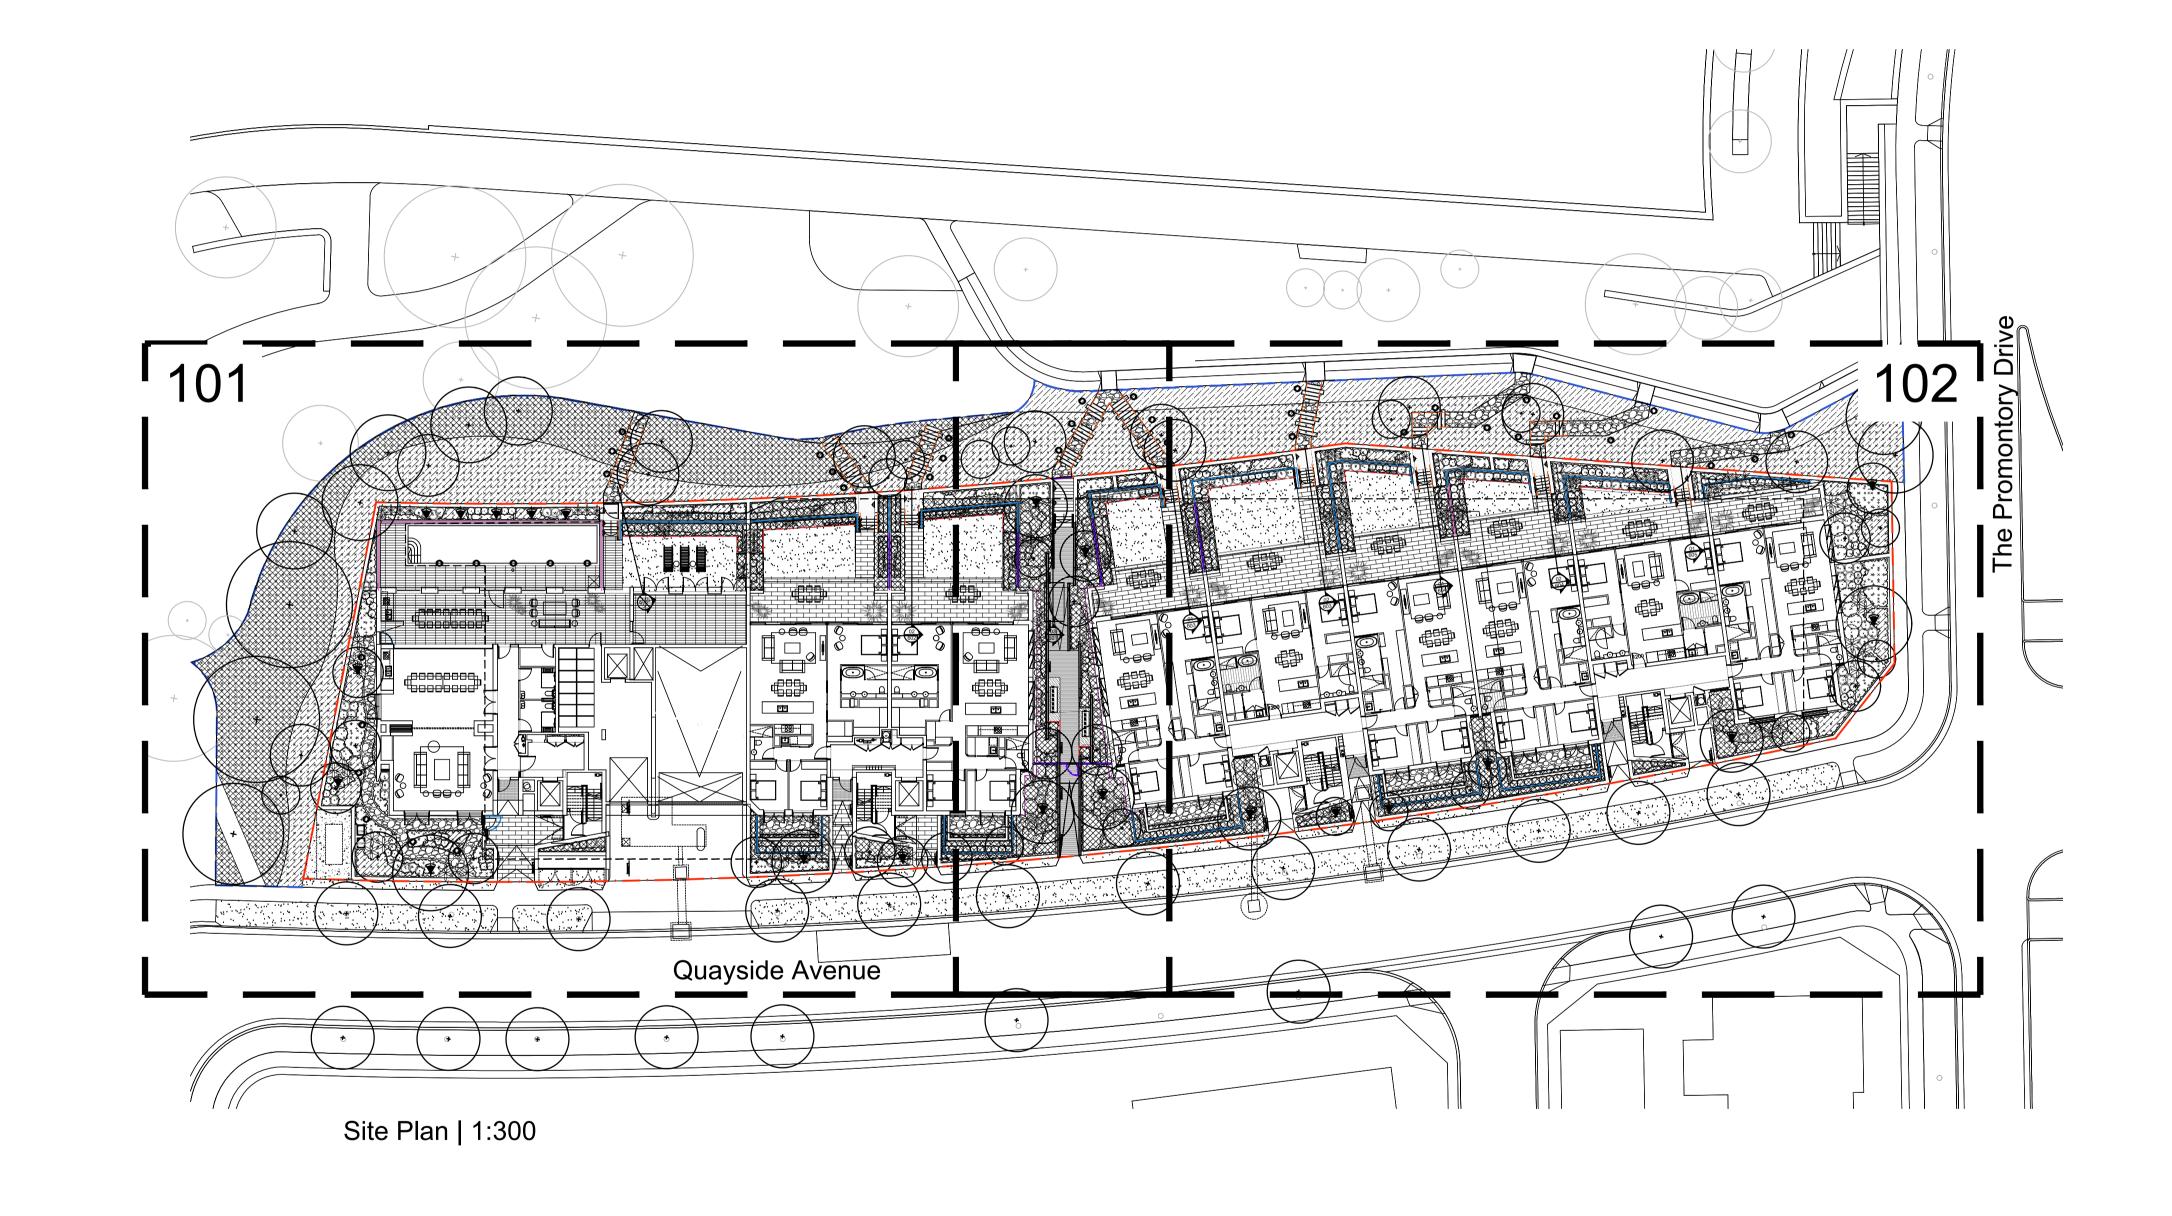
NOT FOR CONSTRUCTION - DESIGN INTENT ONLY WEST ELEVATION 5965 Drawing Number: DA 1203

Shell Cove Precinct C2 Apartments

Landscape Development Application

Drawing Schedule

Drawing Number	Drawing Title	Scale
0000	Landscape Coversheet	N/A
001	Landscape Plan	1:200
002	Landscape Planting Schedule	N/A
101	Landscape Plan - 1	1:100
102	Landscape Plan - 2	1:100
501	Landscape Details	As Shown
502	Landscape Details & Specification	As Shown
503	Landscape Detail	As Shown
601	Landscape Sections	As Shown
602	Landscape Sections	As Shown
603	Landscape Sections	As Shown
604	Landscape Sections	As Shown
605	Landscape Sections	As Shown



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The contractor shall check and verify all work on site (including work by others) before commencing the landscape installation. Any discrepancies are to be reported to the Project Manager or Landscape Architect prior to commencing work. Do not scale this drawing. Any required dimensions not shown shall be referred to the Landscape Architect for confirmation.

 F
 Updated DA Issue
 MW
 NM
 17.05.2022

 E
 Forshore Stairs Updated
 CK
 NM
 01.02.2022

 D
 Foreshore Tree Species Modified
 JD
 NM
 20.01.2022

 C
 Development Application
 JD
 NM
 16.09.2021

 B
 Development Application
 JD
 NM
 14.09.2021

 A
 Preliminary
 JD
 NM
 03.09.2021

 Issue
 Revision Description
 Drawn
 Check
 Date



Frasers Property Australia

Drawing Name:

Coversheet

SS21-4673

000 F

Project:
Precinct C2
Shell Cove

DEVELOPMENT APPLICATION

Scale: 1:200 @ A1

On 1 2 4 6 10m

Job Number: Drawing Number: Issue

ROUND FL	Botanic Name LOOR	Common Name	Mature Size	Pot Size	Density	
1 10	ari odricadio					
EES	Daminis tata a 15 "	One of Decision	4= =	400:	A - C'	
Bi	Banksia integrifolia	Coast Banskia	15 x 5	100L	As Shown	
Bm =-	Backhousia myrtifolia	Cinnamon Myrtle	3 x 2	75L	As Shown As Shown	
Er Cs	Eucalyptus robusta Callistemon salignus	Swamp Mahogany Willow Bottlebrush	20 x 15 10 x 5	100L 75L	As Shown	
TL	Tristaniopsis laurina 'Luscious'	Water Gum	8 x 4	75L 75L	As Shown	
MI	Melaleuca linariifolia	Snow in Summer	8 x 5	100L	As Shown	
••••	melaleded midimena		0 / 0	1002	7.60 0110 1111	
RUBS						
An	Alpinia nutans	Dwarf Cardamom	1.5 x 1	300mm	As Shown	
Bi	Baeckea imbricata	Heath Myrtle	0.8 x 1	300mm	As Shown	
Bs	Banksia spinulosa	Hills Banksia	3 x 2	300mm	As Shown	
CLJ	Callistemon 'Little John'	Bottlebrush Little John	1.5 x 1.5	300mm	As Shown	
CGB	Callistemon Great Balls of Fire	Bottlebrush	1.75 x 1.75	300mm	As Shown	
Ca	Correa alba	Native Fuchsia	1.5 x 1.5	300mm	As Shown	
CDB	Correa 'Dusky Bells'	Native Fuchsia	.5 x 1	300mm	As Shown	
De	Doryanthes excelsa	Gymea Lily	2 x 2	300mm	As Shown	
Me	Monotoca elliptica	Tree Broom Heath	2 x 3	300mm	As Shown	
МСТ	Melaleuca linariifolia 'Claret Tops'	Honey Myrtle	1.2 x 1	300mm	As Shown	
MT LF	Metrosideros collina 'Tahiti' Leptospermum laevigatum Foreshore	Dwarf NZ Christmas Bush	1 x 1	300mm	As Shown	
LF PMM	Pittosporum 'Miss Muffet'	Dwarf Coastal Tea Tree	0.5 x 1 1 x 1.5	300mm	As Shown As shown	
Sa	Scaevola aemula	Dwarf Pittosporum Fairy Fan Flower	0.5 x 1	300mm 300mm	As shown	
WGB	Westringia fruticosa 'Grey box'	Grey Box	0.5 x 0.5	300mm	As shown	
WBG	Westringia fruticosa 'Blue Gem'	Blue Gem	1.5 x 1.3	300mm	As shown	
WM	Westringia fruticosa 'Mundi'	Coastal Rosemary	0.5 x 1.5	300mm	As shown	
	g.a anoood mandi	Judan Robolilary	0.0 X 1.0	55011111	, to other	
CENTS						
Aa	Asplenium australasicum	Birds Nest Fern	1 x 1	300mm	As Shown	
BSL	Blechnum 'Silver Lady'	Silver Lady Fern	1.2 x 1	300mm	As shown	
Ag	Agave geminiflora	Twin Agave	0.8 x 1	300mm	As Shown	
PBB	Phormium Bronze Baby	Dwarf Flax	1 x 1	300mm	As Shown	
	GROUND COVERS	_				
Ac	Arthopodium cirratum	Renga Lily	.6 x .6	150mm	5/m2	
As	Austrostipa stipoides	Coastal Spear Grass	0.8 x 0.8	150mm	5/m2	
CKK	Casuarina glauca 'Kattang Karpet'	Prostrate She Oak	.5 x 2	150mm	5/m2	
Сар	Chrysocephalum apiculatum	Common Everlasting	2 x 1	150mm	5/m2	
Cc	Convolvulus cneorum	Silver Bush	0.6 x 0.6	150mm	5/m2	
Dc CD	<i>Dianella caerulea</i> <i>Grevillea</i> 'Poorinda Royal Mantle'	Blue Flax Lily Grevillea	0.6 x 0.3 0.1 x 3	150mm 150mm	5/m2	
GP ⊔n	Helichrysum petiolare	Licorice Plant	0.1 x 3 .4 x 1.5	150mm 150mm	5/m2 5/m2	
Hp Hs	Hibbertia scandens	Guinea Flower	.4 x 1.5	150mm	5/m2	
HM	Hardenbergia violacea 'Meema'	Purple Coral Pea	0.5 x 2	150mm	5/m2	
LS	Lomandra confertifolia 'Seascape'	Mat Rush	0.5 x 0.6	150mm	5/m2	
LC	Lomandra 'Crackerjack'	Crackerjack	1 x 1	150mm	5/m2	
Мр	Myoporum parvifolium purpurea	Creeping Boobialla	0.3 x 3	150mm	5/m2	
Pp	Poa poiformis	Blue Tussock Grass	0.6 x 0.5	150mm	5/m2	
SBC	Senecio serpens 'Blue Chalksticks'	Blue Chalksticks	0.6 x 0.6	150mm	5/m2	
Dr	Dichondra repens	Kidney Weed	.1 x 1.5	150mm	5/m2	
DSF	Dichondra 'Silver Falls'	•	.1 x 1.5	150mm	5/m2	
Vh	Viola hederacea	Native Violet	.1 x .5	150mm	5/m2	
ммон о	PEN SPACE					
Ln	Laurus nobilis	Bay Tree	7 x 3	100L	As Shown	
So	Salvia officinalis	Sage	.1 x .2	150mm	As Shown	
Tv	Thymus vulgaris	Common Thyme	.2 x .5	150mm	As Shown	
Ro	Rosmarinus officinalis	Rosemary	1 x 1	150mm	As Shown	
Ov Tc	Origanum vulgare Thymus x citriodorus	Oregano Lemon Scented Thyme	.2 x .2 .2 x .2	150mm 150mm	As Shown As Shown	
Ld	Lavandula detata	French Lavender	.2 x .2 .6 x .6	300mm	As Shown	
Tvi	Tulbaghia violacea	Society Garlic	.5 x .3	150mm	As Shown	
	raibagina violacea	Society dame	.0 % .0	13011111	A3 3110WII	
RESHOR	E PLANTING TREES					
-	Species	Common Name	Mature Size	Pot Size	Spacing	
_	•		(h x w) m		-	
Bi	Banksia integrifolia	Coastal Banksia	15 x 6	200L	As shown	
Cs	Callistemon salignus	Willow Bottlebrush	5 x 3	200L	As shown	
Ea	Eucalyptus amplifolia	Cabbage Gum	20 x 8	200L	As shown	
Eb	Eucalyptus botryoides Hibiscus tiliaceus	Southern Mahogany Beach Hibiscus	15 x 12	200L	As shown	
Ht Ti	Hibiscus tiliaceus Tristaniopsis laurina	Beach Hibiscus Water Gum	8 x 5 8 x 5	200L 200L	As shown As shown	
"	тнасалораю іашіна	vvater Guill	OXO	ZUUL	UMOIIE eu	
RESHOP	E PLANTING TALL SHRUBS					
J.IUK	Species	Common Name	Mature Size	Pot Size	Spacing	Percentage of M
	•		(h x w) m		- 4-21118	•
Be	Banksia ericifolia	Heath Banksia	5.0 x 2	150mm		16.36%
Ca	Correa alba	White correa	1.2 x 1.5	150mm		22.27%
Me	Melaleuca ericifolia	Swamp paperbark	3.0 x 2.0	150mm	2.5/m²	12.02%
Mh	Melaleuca hypericifolia	Hillock Bush	1.5 x 1.5	150mm	2.0/111	18.06%
MCT	Melaleuca linarifolia 'Claret Tops'	Honey Myrtle	1.4 x 1.0	200mm		21.72%
WBG	Westringia fruticosa 'Blue Gem'	Native Rosermary	1.2 x 1.2	150mm		9.57%
DEGLICE	E DI ANTINO I OM ODAGGEGANE GEGI	INDCOVERS				
KESHOR!	E PLANTING LOW GRASSES AND GROU		Moture Oile	Dot Ole	Charles	Doroomton of T
	Species	Common Name	Mature Size (h x w) m	Pot Size	Spacing	Percentage of M
	Acceptance Control Control	Prickly Spear Grass	1.0 x 0.5	150mm		7.10%
As	Austrostipa stipoides	Correa	0.7 x 1.0	150mm		4.62%
	Austrostipa stipoides Correa 'Dusky Bells'		0.3 x 2	150mm		2.13%
As CDB		Pigface		150mm		15.79%
As	Correa 'Dusky Bells'	Pigface Blue Flax-Lily	0.3×0.4	100111111		13.7370
As CDB Cg	Correa 'Dusky Bells' Carpobotus glaucescens		0.3 x 0.4 0.5 x 0.8	150mm		4.28%
As CDB Cg Dc	Correa 'Dusky Bells' Carpobotus glaucescens Dianella caerulea	Blue Flax-Lily				4.28%
As CDB Cg Dc GCC GCC	Correa 'Dusky Bells' Carpobotus glaucescens Dianella caerulea Grevillea juniperina 'Cherry Cluster' Grevillea juniperina 'Gold Cluster'	Blue Flax-Lily Grevillea Cherry Cluster Gold Cluster	0.5 x 0.8 0.3 x 0.9	150mm	<u> </u>	4.28% 4.28%
As CDB Cg Dc GCC GGC	Correa 'Dusky Bells' Carpobotus glaucescens Dianella caerulea Grevillea juniperina 'Cherry Cluster' Grevillea juniperina 'Gold Cluster' Grevillea lanigera	Blue Flax-Lily Grevillea Cherry Cluster	0.5 x 0.8	150mm 150mm	2.5/m²	4.28% 4.28% 3.67%
As CDB Cg Dc GCC GGC GI	Correa 'Dusky Bells' Carpobotus glaucescens Dianella caerulea Grevillea juniperina 'Cherry Cluster' Grevillea juniperina 'Gold Cluster' Grevillea lanigera Hardenbergia 'Meema'	Blue Flax-Lily Grevillea Cherry Cluster Gold Cluster Woolly Grevillea Coral Pea	0.5 x 0.8 0.3 x 0.9 0.8 x 0.8	150mm 150mm 150mm	2.5/m²	4.28% 4.28% 3.67% 9.31%
As CDB Cg Dc GCC GGC GHM LS	Correa 'Dusky Bells' Carpobotus glaucescens Dianella caerulea Grevillea juniperina 'Cherry Cluster' Grevillea juniperina 'Gold Cluster' Grevillea lanigera Hardenbergia 'Meema' Lomandra confertifolia 'Seascape'	Blue Flax-Lily Grevillea Cherry Cluster Gold Cluster Woolly Grevillea Coral Pea Lomandra Seascape	0.5 x 0.8 0.3 x 0.9 0.8 x 0.8 0.5 x 1.0	150mm 150mm 150mm 150mm	2.5/m²	4.28% 4.28% 3.67% 9.31% 15.03%
As CDB Cg Dc GCC GGC HM LS LH	Correa 'Dusky Bells' Carpobotus glaucescens Dianella caerulea Grevillea juniperina 'Cherry Cluster' Grevillea juniperina 'Gold Cluster' Grevillea lanigera Hardenbergia 'Meema' Lomandra confertifolia 'Seascape' Lomandra 'Hystrix'	Blue Flax-Lily Grevillea Cherry Cluster Gold Cluster Woolly Grevillea Coral Pea	0.5 x 0.8 0.3 x 0.9 0.8 x 0.8 0.5 x 1.0 0.5 x 0.5	150mm 150mm 150mm 150mm 150mm	2.5/m²	4.28% 4.28% 3.67% 9.31% 15.03% 7.29%
As CDB Cg Dc GCC GGC HM LS LH Mp	Correa 'Dusky Bells' Carpobotus glaucescens Dianella caerulea Grevillea juniperina 'Cherry Cluster' Grevillea juniperina 'Gold Cluster' Grevillea lanigera Hardenbergia 'Meema' Lomandra confertifolia 'Seascape' Lomandra 'Hystrix' Myoporum parvifolium	Blue Flax-Lily Grevillea Cherry Cluster Gold Cluster Woolly Grevillea Coral Pea Lomandra Seascape Tropic Cascade	0.5 x 0.8 0.3 x 0.9 0.8 x 0.8 0.5 x 1.0 0.5 x 0.5 0.7 x 0.7 0.1 x 1.0	150mm 150mm 150mm 150mm 150mm	2.5/m²	4.28% 4.28% 3.67% 9.31% 15.03% 7.29% 5.89%
As CDB Cg Dc GCC GGC GI HM LS LH Mp RFB	Correa 'Dusky Bells' Carpobotus glaucescens Dianella caerulea Grevillea juniperina 'Cherry Cluster' Grevillea juniperina 'Gold Cluster' Grevillea lanigera Hardenbergia 'Meema' Lomandra confertifolia 'Seascape' Lomandra 'Hystrix' Myoporum parvifolium Rhagodia spinescens Flat Bush	Blue Flax-Lily Grevillea Cherry Cluster Gold Cluster Woolly Grevillea Coral Pea Lomandra Seascape Tropic Cascade Yareena Salt Bush	0.5 x 0.8 0.3 x 0.9 0.8 x 0.8 0.5 x 1.0 0.5 x 0.5 0.7 x 0.7 0.1 x 1.0 0.3 x 1.0	150mm 150mm 150mm 150mm 150mm 150mm 150mm	2.5/m²	4.28% 4.28% 3.67% 9.31% 15.03% 7.29% 5.89% 6.46%
As CDB Cg Dc GCC GGC HM LS LH Mp	Correa 'Dusky Bells' Carpobotus glaucescens Dianella caerulea Grevillea juniperina 'Cherry Cluster' Grevillea juniperina 'Gold Cluster' Grevillea lanigera Hardenbergia 'Meema' Lomandra confertifolia 'Seascape' Lomandra 'Hystrix' Myoporum parvifolium	Blue Flax-Lily Grevillea Cherry Cluster Gold Cluster Woolly Grevillea Coral Pea Lomandra Seascape Tropic Cascade Yareena	0.5 x 0.8 0.3 x 0.9 0.8 x 0.8 0.5 x 1.0 0.5 x 0.5 0.7 x 0.7 0.1 x 1.0	150mm 150mm 150mm 150mm 150mm 150mm	2.5/m²	4.28% 4.28% 3.67% 9.31% 15.03% 7.29% 5.89%








Tristaniopsis laurina 'Luscious'



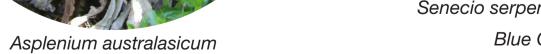



Lomandra confertifolia 'Seascape' Mat Rush



Baeckea imbricata Heath Myrtle



Austrostipa stipoides Coastal Spear Grass



Senecio serpens 'Blue Chalksticks' Blue Chalksticks



Metrosideros collina 'Tahiti'



Westringia fruticosa 'Grey box'



Convolvulus cneorum Silver Bush



Dianella caerulea Blue Flax Lily



Correa alba Native Fuchsia



Monotoca elliptica Tree Broom Heath



Agave geminiflora



Hardenbergia violacea 'Meema'



Hibiscus tiliaceus Red Cottonwood



Eucalyptus robusta



Poa poiformis Blue Tussock Grass



Grevillea 'Poorinda Royal Mantle' Grevillea

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Forshore Stairs Updated Foreshore Tree Species Modified Development Application B Development Application A Preliminary

Issue Revision Description

CK NM 01.02.2022 JD NM 20.01.2022 JD NM 16.09.2021 JD NM 14.09.2021 JD NM 03.09.2021

Drawn Check Date

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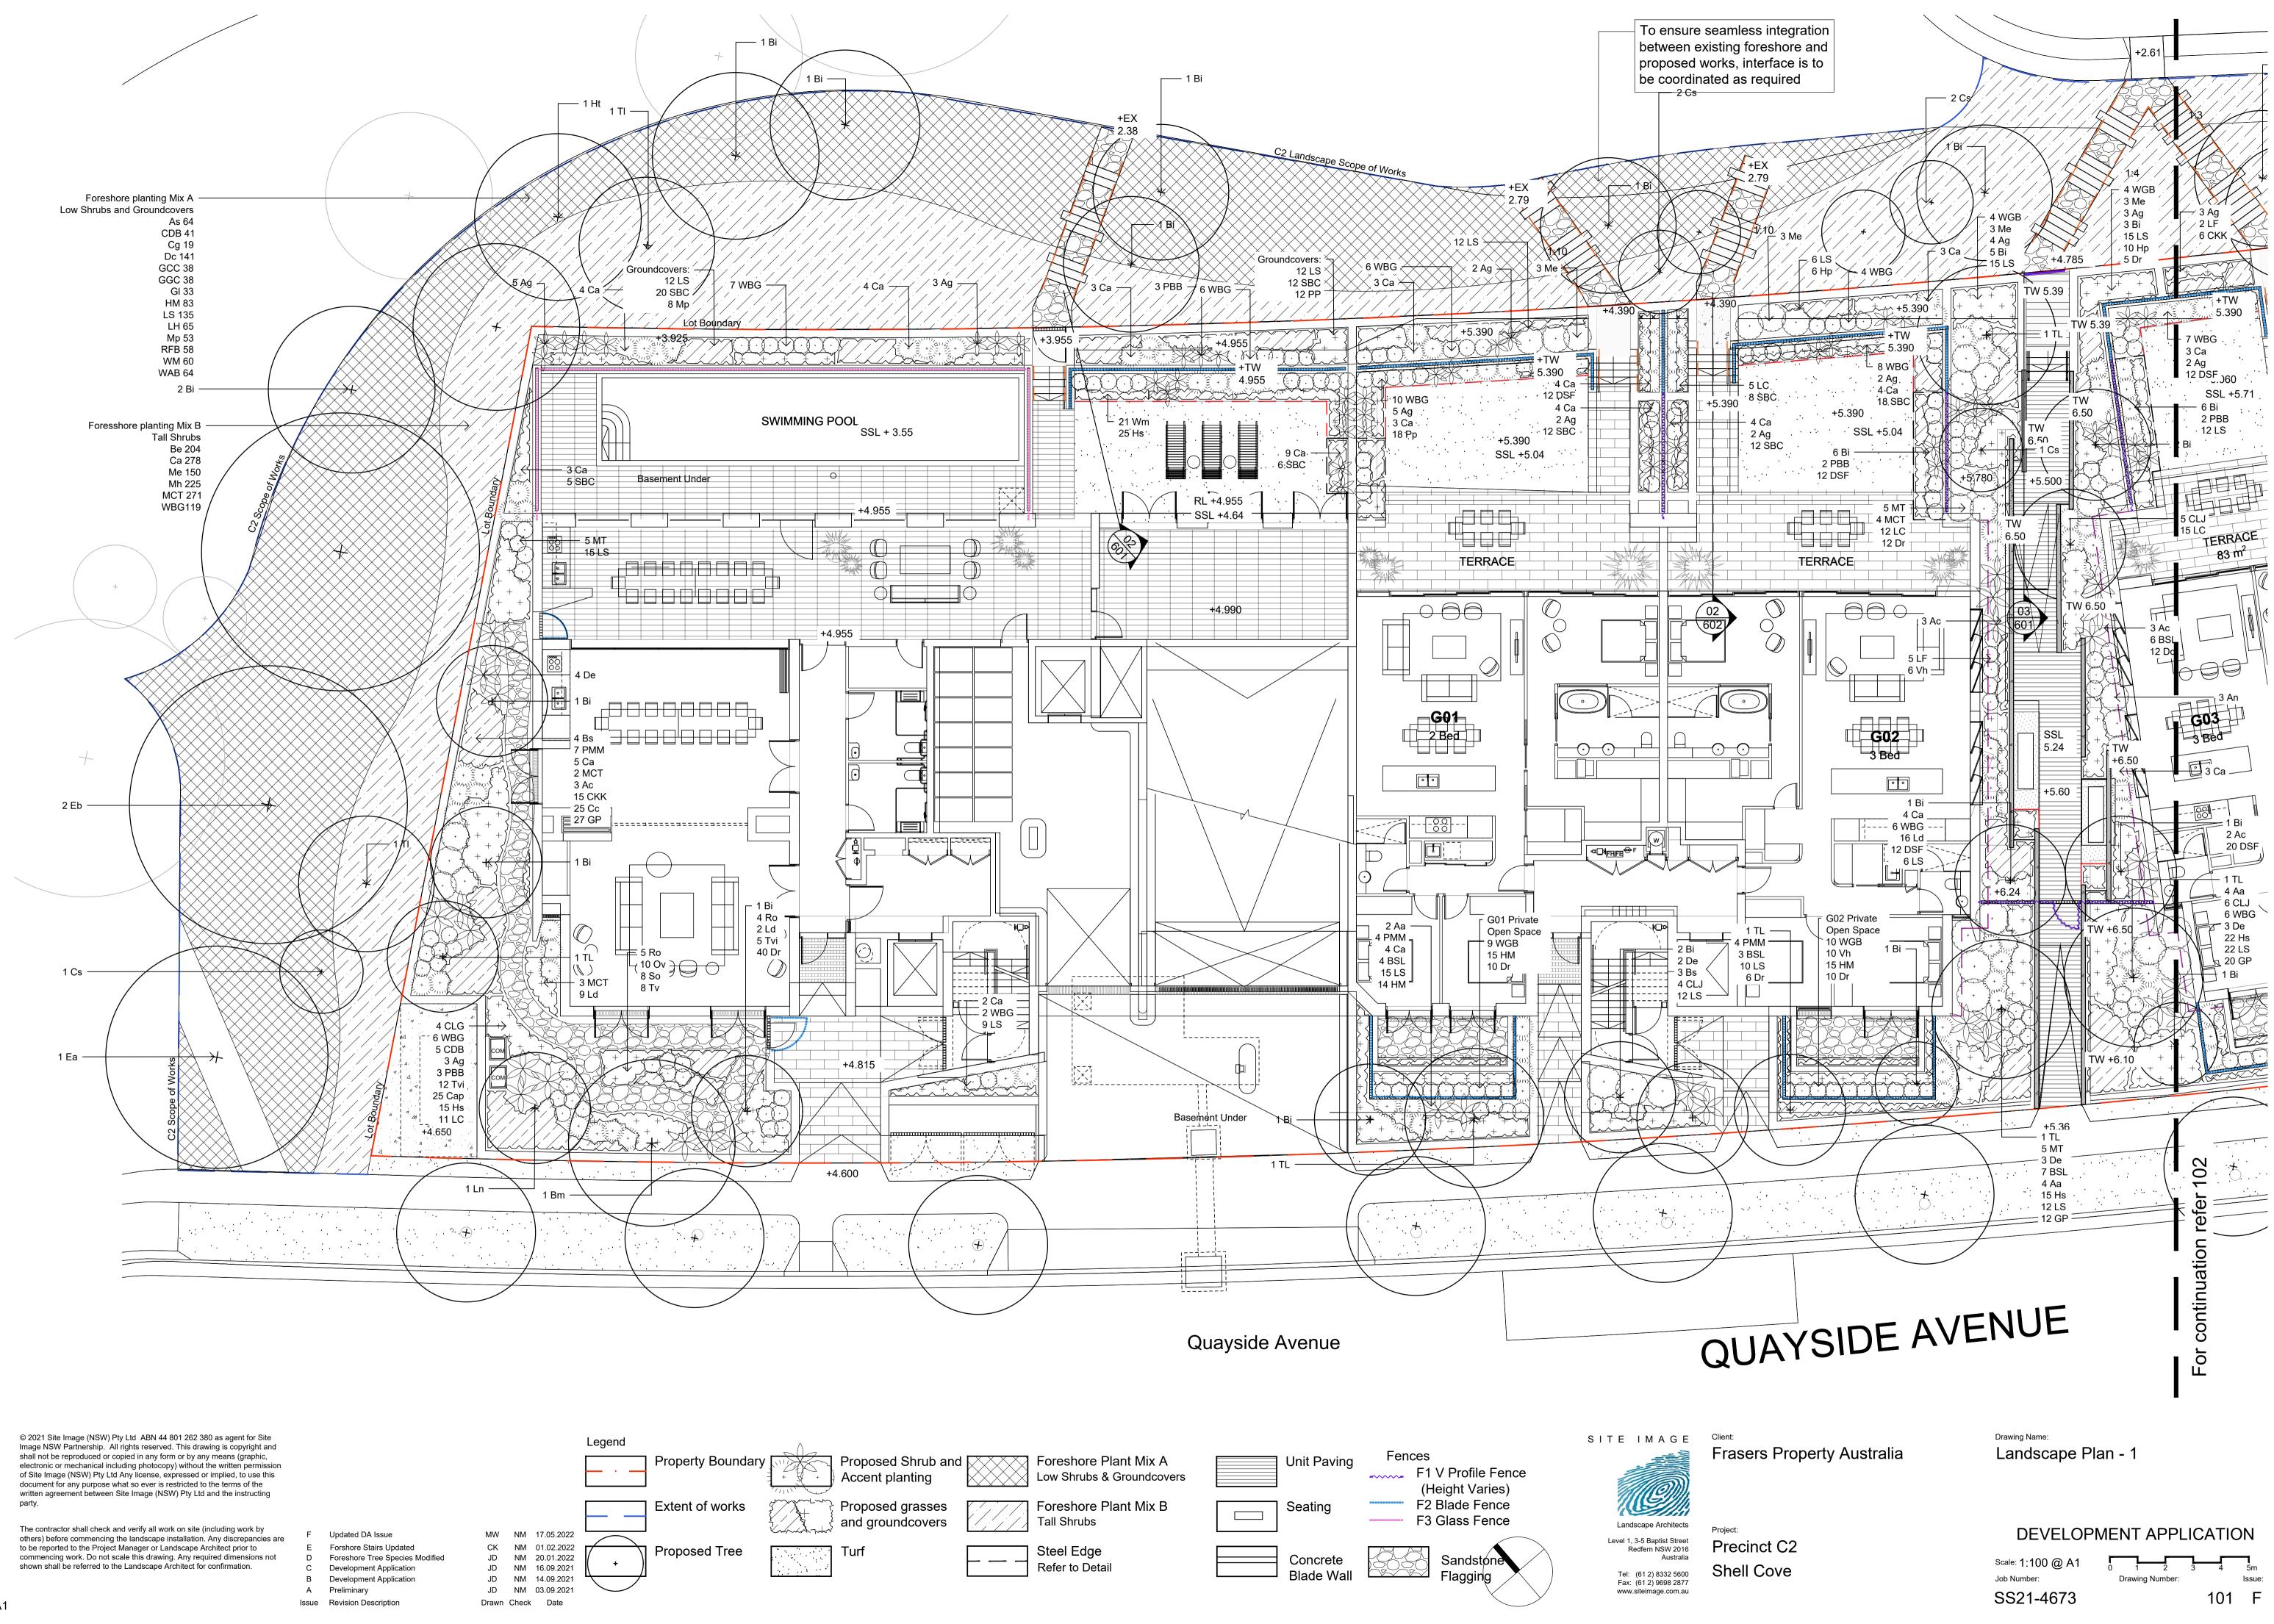
Precinct C2 Shell Cove


Landscape Planting Schedule


DEVELOPMENT APPLICATION Scale: 1:200 @ A1


Job Number: Drawing Number: SS21-4673 002 E






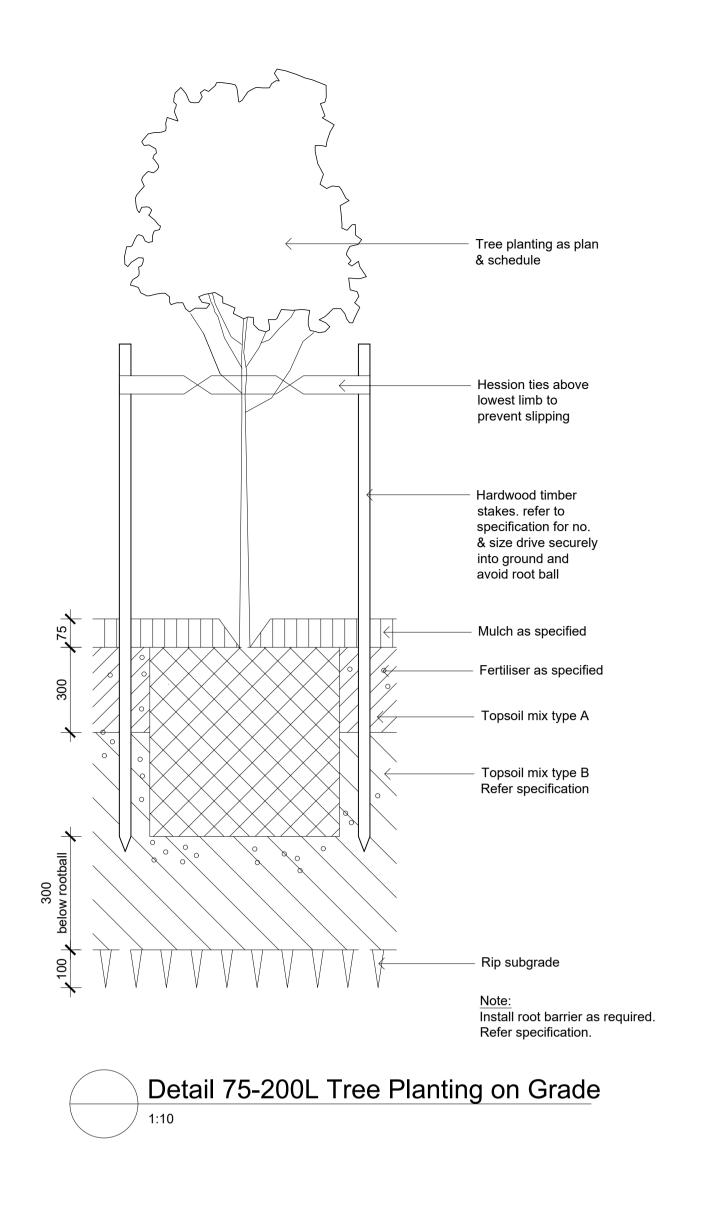

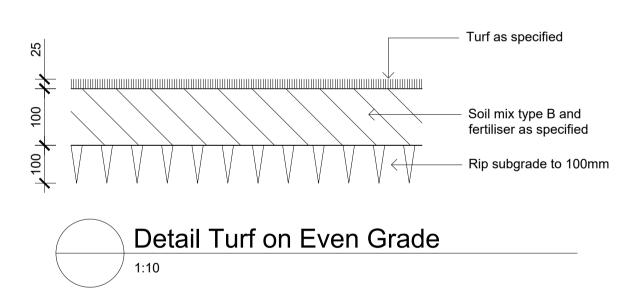

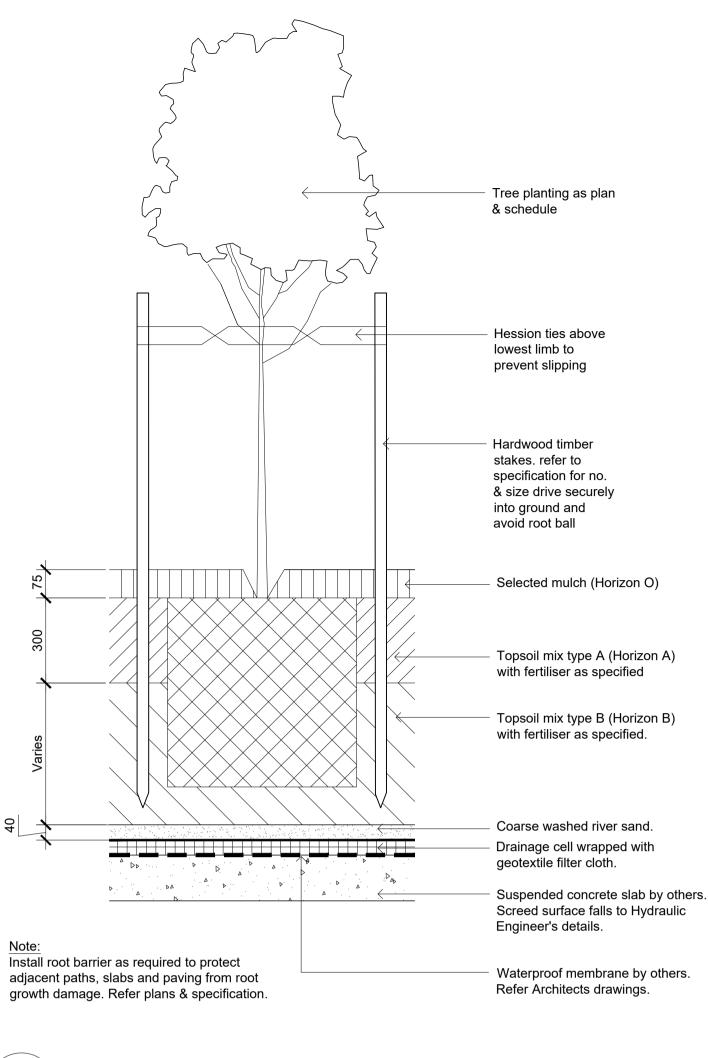


Detail 75-200L Tree Planting on Structure

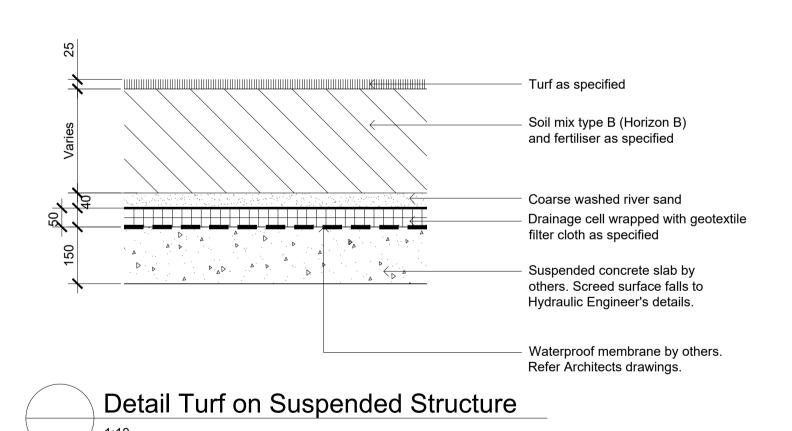


Shrub, accent & groundcover planting refer plan & schedule Mulch as specified Fertiliser Refer specification Soil mix type A Soil mix type B Rip subgrade to 100mm

Shrub Accent & Groundcover Planting on Grade

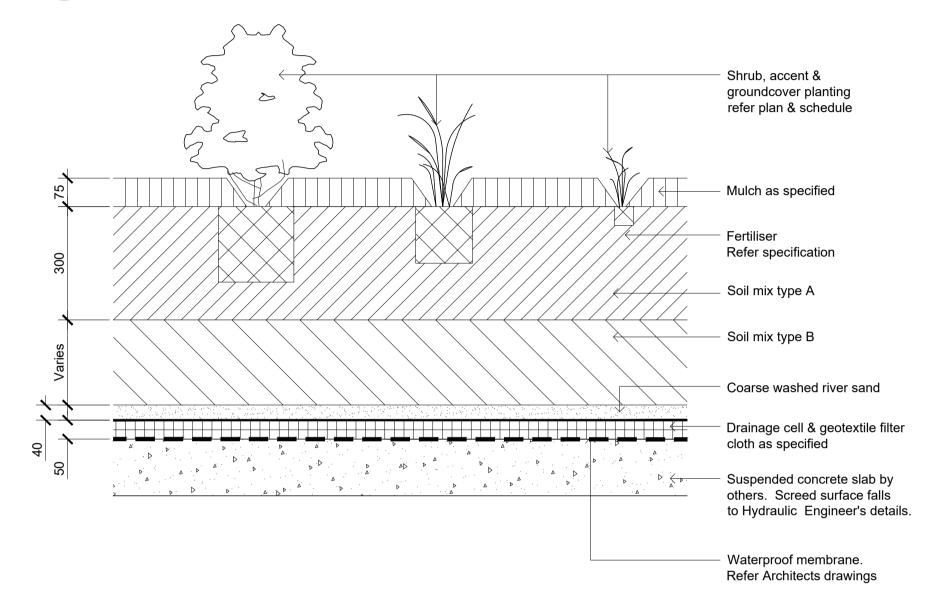

Shrub Accent & Groundcover Planting on Structure

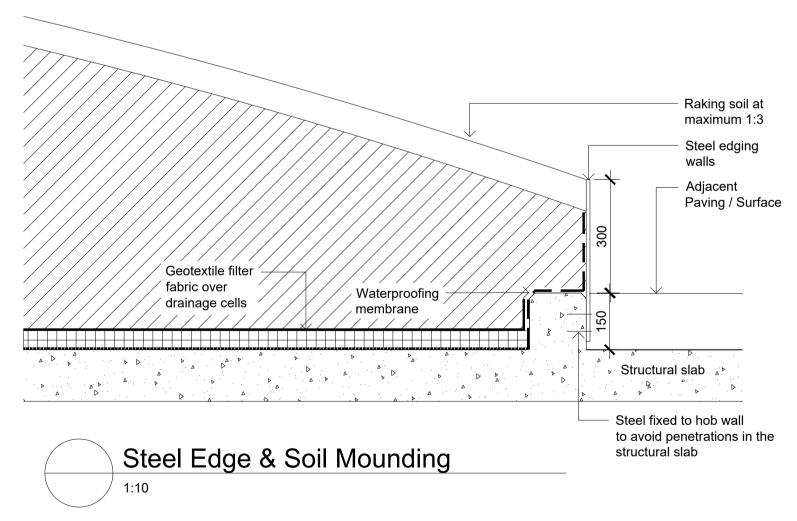

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Development Application A Preliminary

JD NM 16.09.2021 JD NM 14.09.2021 JD NM 03.09.2021 Drawn Check Date

Legend

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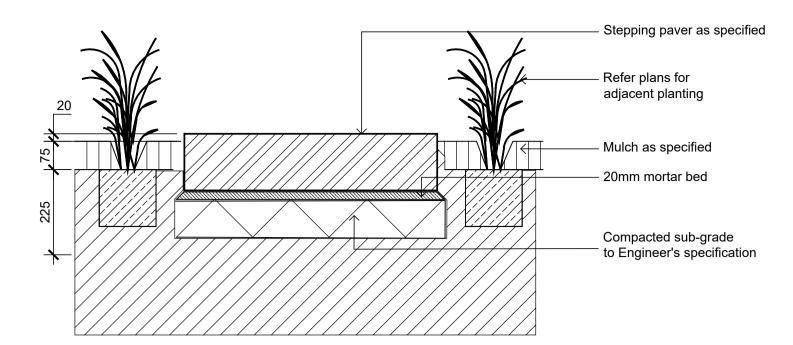
Landscape Details

DEVELOPMENT APPLICATION


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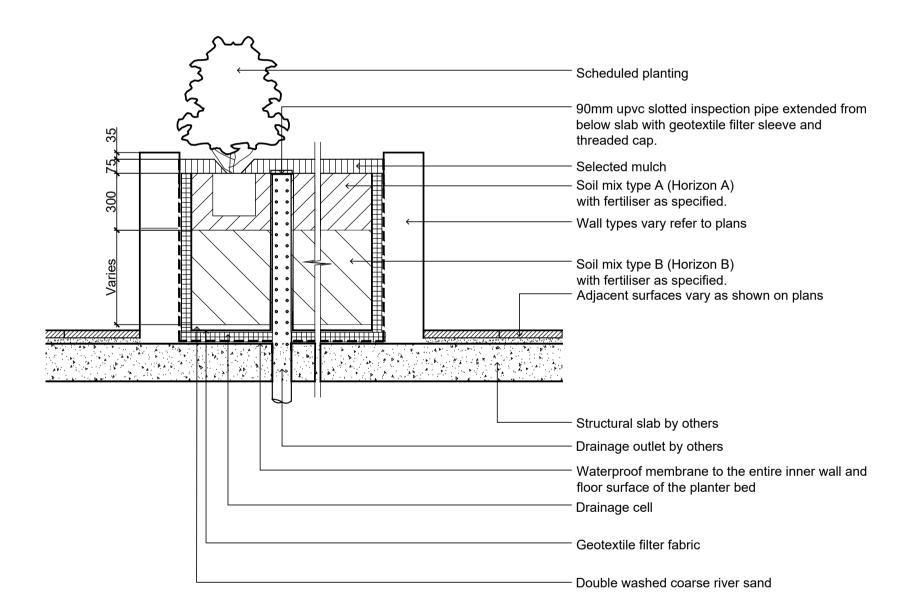
SS21-4673

Drawing Number: 501 C







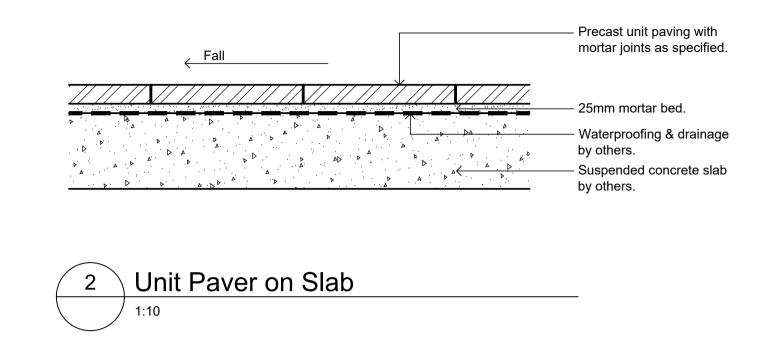

Typical Raised Planter Bed on Structure Inspection riser pipe

Ma	intenance Prograr	n							
	Activity	Frequency							Action
		D	W	2W	3W	М	ЗМ	6M	
1	Logbook	+		+		+			Complete a logbook entry every day at site and at least every two weeks. All actions listed below require a logbook entry. Upon request, make the logbook available for inspection. Submit copies of new entries in the logbook to the Contract Administrator on a monthly basis. Please note that more frequent, short, occasional inspection should result in less maintenance work when problems are observed earlier than they might otherwise have been seen.
2	Plant Replacement			+		+			Inspect and replace failed plants within 2 weeks of observation of failure. Match species, size (original) and location of new with old.
3	Mulch			+		+			Inspect and replace mulch deficiencies within 2 weeks of observation. Prior to placing new mulch aerate the soil by fork turning to a depth of at least 100mm, roughly level the soil and then place mulch. Do not disturb major plant roots while aerating soil.
4	Erosion Control			+					Inspect every two weeks and repair ground, soil and mulch immediately. Maintain erosion control device as necessary.
5	Stakes and ties			+					Inspect every two weeks, adjust and/or replace as necessary but remove as plants mature and are able to support themselves.
6	Weed and Rubbish removal			+					Inspect and remove immediately upon observation. Leave no waste on site. Dispose of waste material at a designated waste disposal site
7	Pruning			+					Inspect every 2 weeks and prune as necessary to remove dead wood, improve plant shape and promote healthy vigorous new growth.
8	Spraying			+					Inspect every 2 weeks and action as necessary. Do not spray if other non-chemical methods will satisfy the need to remove insects. Spray for disease control only when absolutely necessary.
9	Urgent Works		+						Complete within 1 week (7 days) of notification. Inspect and clear drains.
10	Planting and fertilising			+			+		Inspect every 2 weeks and remove spent flowers and dead stalks as they become apparent. Fertilise gardens every 3 months or other frequency in accordance with fertiliser manufacturer's directions.
11	Watering	+		+					Water when and where necessary every day at site and at least every 2 weeks generally. Do not allow soil and plants to dehydrate. Allow for prolonged rain, windy and dry periods. Water in the early morning or late afternoon to avoid excessive evaporation during the heat of the day.
12	Mowing, top dressing and edging			+		+		+	Summer fortnightly. Winter monthly. Top-dress 6 monthly.

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Forshore Stairs Updated CK NM 01.02.2022 JD NM 20.01.2022 Foreshore Tree Species Modified **Development Application** JD NM 16.09.2021 **Development Application** A Preliminary Issue Revision Description

JD NM 14.09.2021 JD NM 03.09.2021 Drawn Check Date

SPECIFICATION

GENERAL NOTES

All plans and details included in the project documents shall be read in conjunction with this specification. All structural and civil works components of the landscape design shall be referenced to engineers' details and specifications. Read this specification in conjunction with the plant and materials schedule on this drawing. If in doubt about any detail or if conflicts are found in the documents, seek

Workmanship and Materials

The whole of the landscape works shall be carried out by a competent, trained and qualified landscape contractor who is experienced in horticultural practices, landscape construction and planting techniques. The landscape contractor shall hold a current Building Contractors License and/or be a financial member of LNA Landscape Association NSW & ACT or equivalent organisations in other states.

EXISTING TREES

Trees to be Retained and Protected

Identify and mark trees and shrubs to be retained using a suitable non-injurious, easily visible and removable means of identification. Protect from damage the trees and shrubs to be retained, including those beyond the site area, both above and below the ground. If a tree becomes damaged during the works or it is proposed to perform work on a tree, give written notice immediately and obtain instructions.

Keep the area of the drip-line free from construction material and debris. Do not place bulk materials and harmful materials under or near trees. Do not place spoil from excavations against tree trunks. Prevent wind-blown materials such as cement from harming trees and plants. Do not remove topsoil from, or add topsoil to, the area within the drip-line of trees.

EARTHWORKS

Excavation, Trimming and Filling

Except as otherwise note in the contract, bulk excavation is excluded from the landscape works. Trim and fill the excavated ground surfaces to achieve design levels to accommodate finish materials as detailed. Compact the finished surface as required for the finished ground treatment.

Sub-soil Drainage

Keep the excavated works drained and free of standing water. Allow to supply and install sub-soil drainage pipes as required for the new works to ensure that all gardens are well drained. Connect the sub-soil drainage pipes to the nearest downstream stormwater pits. Include pipe filter socks.

HARDWORKS

Furniture, Handrails, Balustrades

Supply and install the scheduled items in accordance the manufacturer's recommendations, as detailed and in the locations shown on plan. Provide all footings and fixings required for the items to be stable and in accordance with applicable codes and standards.

Garden Walls, Fences, Steps, TGSI and Edging

Construct garden walls as shown on plan, as detailed and of the material scheduled. Provide footings, step nosings, tactile surfaces to comply with standards and applicable legislation.

Continuous, Unit and Loose Pavement

Install the scheduled material pavement to the locations shown on plan. Ensure that all subgrade/subsurface works are complete prior to commencing paving. Confer with the engineer to ensure the structural integrity of the installation.

SOFTWORKS

Undertake at least two (2) soil tests, in locations as advised by Project Manager, and provide results and

recommendations for the improvement of plant growth and to adjust the soil to achieve appropriate planting medium (including pit levels) for successful plant growth.

Excavate all garden beds to bring the subsoil to at least 300mm below finished design levels. Shape the subsoil to fall to subsoil drains where applicable. Do not excavate within the drip line of trees to be retained. Excavate all turf areas to bring the subsoil to at least 100mm below finished design levels. Shape the subsoil to fall to subsoil drains where applicable. Do not excavate within the drip line of trees to be retained. Cultivate the subsoil to a further depth of 100mm. Remove stones exceeding 25mm, clods of earth exceeding 50mm, and weeds, rubbish or other deleterious material brought to the surface during cultivation. Do not disturb services or tree roots, if necessary cultivate these areas by hand. During cultivation, thoroughly mix in materials required to be incorporated into the subsoil, as recommended in the soil testing results and to manufacturer's recommendations. Trim the surface to design levels after cultivation.

Import topsoil for the garden and turf areas, unless the topsoil can be provided from material recovered from the site, as recommended in the soil testing results. Spread the topsoil on the prepared subsoil and grade evenly, compact lightly and uniformly in 150mm layers. Avoid differential subsidence and excess compaction and produce a finished topsoil surface which has the following characteristics:

- Finished to design levels, allowing for mulch or turf, which is to finish flush with adjoining hard
- surfaces such as paths and edge; Smooth and free from stones or lumps of soil;
- Graded to drain freely, without ponding, to catchment points;
- Graded evenly to adjoining surfaces; and
- Ready for planting.

Provide, in accordance with AS 4454, well rotted vegetative material or animal manure, free from

harmful chemicals, grass and weed growth.

Provide proprietary fertilisers, delivered to the site in sealed bags marked to show manufacturer or

vendor, weight, fertiliser type, N:P:K ratio, recommended uses and application rates.

Supply plants in accordance with the landscape drawings and schedules, which have the following

• Large healthy root systems, with no evidence of root curl, restriction or damage;

- Vigorous, well established, free from disease and pests, of good form consistent with the species or
- Hardened off, not soft or forced, and suitable for planting in the natural climatic conditions prevailing at the site, and in particular shade conditions;
- Grown in final containers for not less than twelve weeks; Trees, unless required to be multi-stemmed, shall have a single leading shoot; and

• Containers shall be free from weeds and of appropriate size in relation to their container.

Plant Installation

Following excavation of the planting hole place and spread 15gms of wetting agent pre-mixed with one (1) litre of water. Place the plant correctly orientated to north or for best presentation. Backfill the planting holes with specified topsoil mixture. Lightly tamp and water to eliminate air pockets. Ensure the topsoil is not placed over the top of the rootball. Keep the plant stem at the same height above the ground as it was above the soil in the container. Apply fertiliser, as recommended in the soil testing results or in accordance with the manufacturer's recommendations around the plants in the soil at the time of planting.

Embankment Stabilisation

Where necessary to prevent soil erosion or soil movement, stabilise embankments. As a minimum this should be on slopes >1:3. Stabilise embankments using biodegradable fibre reinforced with heavy weight polymer mesh. Lay mesh from top to bottom of slope. Install in accordance with manufacturer's specification, including 300 x 300 mm anchor trenches at top and bottom, backfilled with soil over the mesh and compacted, and U-shaped galvanised steel pegs at 1000 mm centres and 250mm centres at edge overlaps. Plant after matting is installed.

Supply and install root control barriers to all new tree plantings adjacent to walls, paths and all trunk service trenches, where their proximity poses a threat to the stability of the infrastructure. Install in accordance with manufacturer's recommendations

Mulch shall be approved recycled wood fibre or pine bark mulch. Place mulch in all garden beds to a depth of 75mm, after all specified plants are installed. Keep mulch clear of all plant stems and rake to an even surface flush with the surrounding surfaces evenly graded between design surface levels. Over fill to allow mulch to settle to the specified depth.

Stakes and Ties

Stakes shall be durable hardwood, straight, free of knots and twists, pointed at one end, in the following quantities and sizes for each of the various plant pot sizes:

• Plants (>25 lt): 1 off 38 x 38 x 1200mm

• Semi-advanced plants (>75 lt): 2 off 50x50x 1800mm; Advanced (>100 lt): 3 off 50 x 50 x 2400mm.

Turf shall be delivered to site as 25mm minimum thick cut rolls. Obtain turf from a specialist grower of

cultivated turf. Provide turf of even thickness, free from weeds and other foreign matter. Deliver turf to the site within 24 hours of being cut, and lay it within 24 hours of delivery. Prevent it form drying out between cutting and laying. Lay the turf in the following manner: In stretcher pattern, joints staggered and close butted;

• Parallel long sides of level areas, with contours on slopes; & • To finish flush, after tamping, with adjacent finished surfaces of ground.

All proposed landscape areas shall be irrigated.

The irrigation system shall be an automatic fixed drip system, with an irrigation controller self operated via a soil moisture sensor. The system shall be compatible to the type of plant material and rates of water required. Where appropriate adjustable and fully serviceable. The layout of the entire irrigation is to ensure that each individual plant receives the required amount of water to maintain healthy and vigorous growth. The irrigation system shall be such that, component theft, vandalism, over-spray and wetting of paths shall be reduced to a minimum or completely eliminated by the use of drip, pop-up sprinklers and judiciously placed fixed spray emitters. Water to be supplied from rainwater tank. Do not use fine mist type emitters that provide a drifting mist that may wet paths and the buildings.

LANDSCAPE MAINTENANCE The Landscape Contractor shall rectify defects during installation and that become apparent in the works under normal use for the duration of the contract Defects Liability Period. The Landscape Contractor shall maintain the contract areas by the implementation of industry accepted horticultural practices for 52 weeks. The landscape maintenance works shall include, but not be limited to, the following:

- Replacing failed plants;
- Pruning;
- Insect and pest control; Fertilising;
- Stakes and ties; Maintaining mulch; Mowing and top dressing;
- Irrigation and watering;
- Erosion control; and · Weeding and rubbish removal.

Maintenance Log Book Implement and keep a maintenance log book recording when and what maintenance work has been undertaken and what materials, actions and decisions have been used, implemented and concluded to keep the landscape always looking its best.

Maintenance Activities

Schedule the following activities to occur on a timely basis.

 Plant replacement - Replace plants that have failed to mature, die or are damaged. Replacement plants shall be in a similar size and quality and identical species or variety to the plant that has failed. Replacement of plants shall be at the cost of the landscape contractor

unless advised otherwise. If the cause of the failure is due to a controllable situation then correct the situation prior to replacing

• **Pruning** - Prune dead wood, broken limbs, dead or infected foliage and as needed to develop strong, healthy plants to achieve the

- shape and form expected of the plant type. Insect and pest control - Avoid spraying:
- if ever possible; o in wet weather or if wet weather is imminent:
- if target plants are still wet after rain;
- in windy weather; and
- if non-target species are too close. Immediately report to the Project Manager any evidence of intensive weed infestation, insect attack or disease amongst plant material. Submit all proposals to apply chemicals and obtain approval before starting this work. When approved, spray with herbicide, insecticide, fungicide as appropriate in accordance with the manufacturers' recommendations. Record in the logbook all relevant details of
- spraving activities including O Product brand / manufacturer's name,
- Chemical / product name,
- Chemical contents, Application quantity and rate,
- Date of application and location, Results of application, and
- Use approval authority. Fertilising - Fertilise gardens with a proprietary slow release
- fertiliser applied in accordance with the manufacturer's directions and recommendations. Record in the logbook all relevant details of fertilising including:
- Product brand / manufacturer's name, Fertiliser / product name,
- Application quantity and rate, and
- Date of application and location.
- Stakes and ties Adjust and replace as required to ensure plants remain correctly staked. Remove those not required at the end of the planting establishment period (Defects Liability Period).
- Maintaining mulch Maintain the surface in a clean, tidy and weed free condition and reinstate the mulch as necessary to ensure correct depth as specified.
- Mowing and top dressing Mow the turf to maintain a grass height of between 30-50mm. Do not remove more than one third of the grass height at any one time. Remove grass clippings from the site after each mowing. Top dress to a maximum of 10mm to fill
- depressions and hollows in the surface. • Irrigation and watering - Maintain the irrigation system to sure that each individual plant receives the required amount of water to maintain healthy and vigorous growth, adjust and rectify as required.
- Provide additional watering, if necessary. • **Erosion control** - Where necessary, maintain the erosion control devices in a tidy and weed free condition and reinstate as
- necessary to ensure control measures are effective where deemed • Weeding and rubbish removal - During the plant establishment

period remove by hand, rubbish and weed growth that may occur or re-occur throughout all planted, mulched and paved areas. The contractor shall target weeds that are capable of producing a major infestation of unwanted plants by seed distribution. Whenever possible, time weed removal to precede flowering and seed set.

SITE IMAGE

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Landscape Details

Landscape Architects Level 1, 3-5 Baptist Street Redfern NSW 2016 Australia Tel: (61 2) 8332 5600

Fax: (61 2) 9698 2877


Precinct C2 Shell Cove

DEVELOPMENT APPLICATION

SS21-4673

Scale: As Shown Job Number:

Drawing Number: 502 E

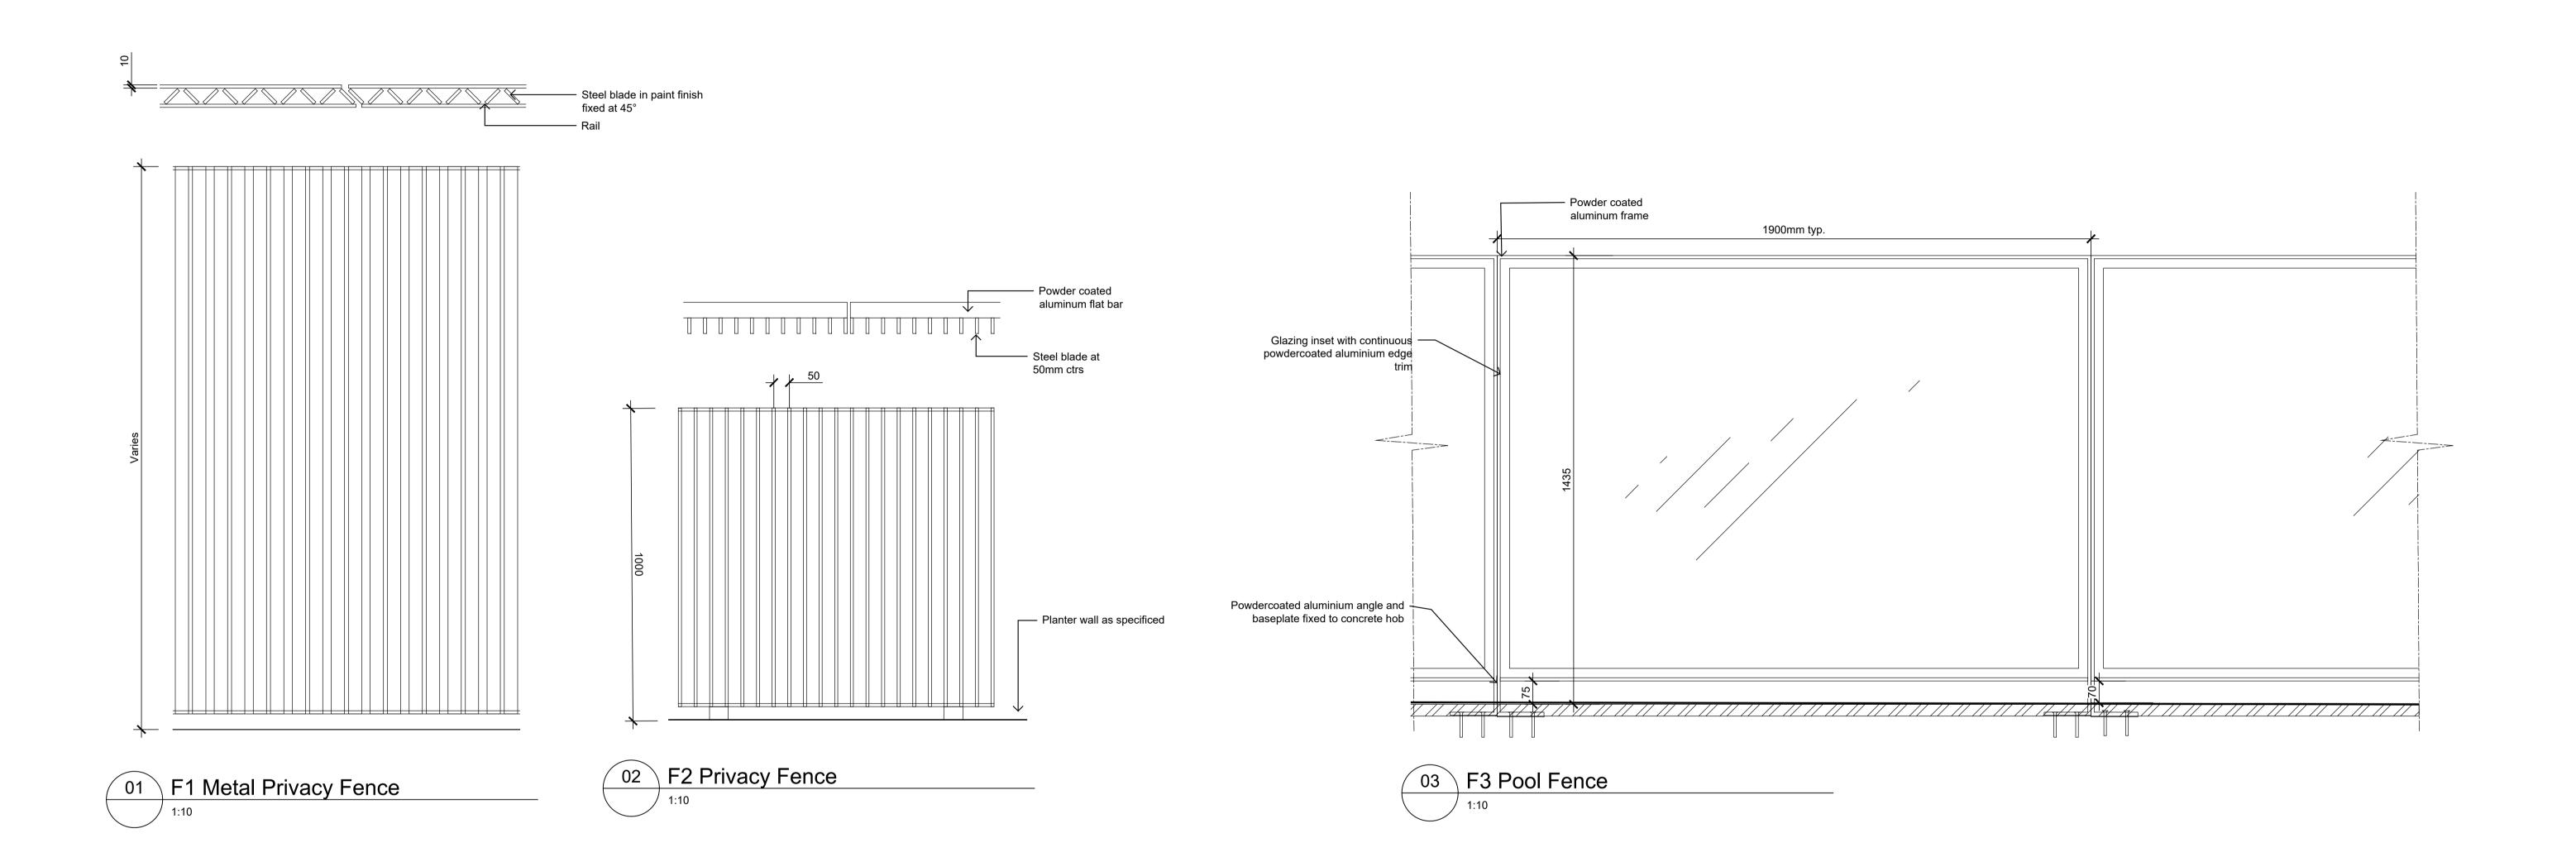

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The contractor shall check and verify all work on site (including work by others) before commencing the landscape installation. Any discrepancies are to be reported to the Project Manager or Landscape Architect prior to commencing work. Do not scale this drawing. Any required dimensions not shown shall be referred to the Landscape Architect for confirmation.

Forshore Stairs Updated CK NM 01.02.2022 Foreshore Tree Species Modified JD NM 20.01.2022 JD NM 16.09.2021 Development Application JD NM 14.09.2021 Development Application A Preliminary JD NM 03.09.2021 Issue Revision Description Drawn Check Date



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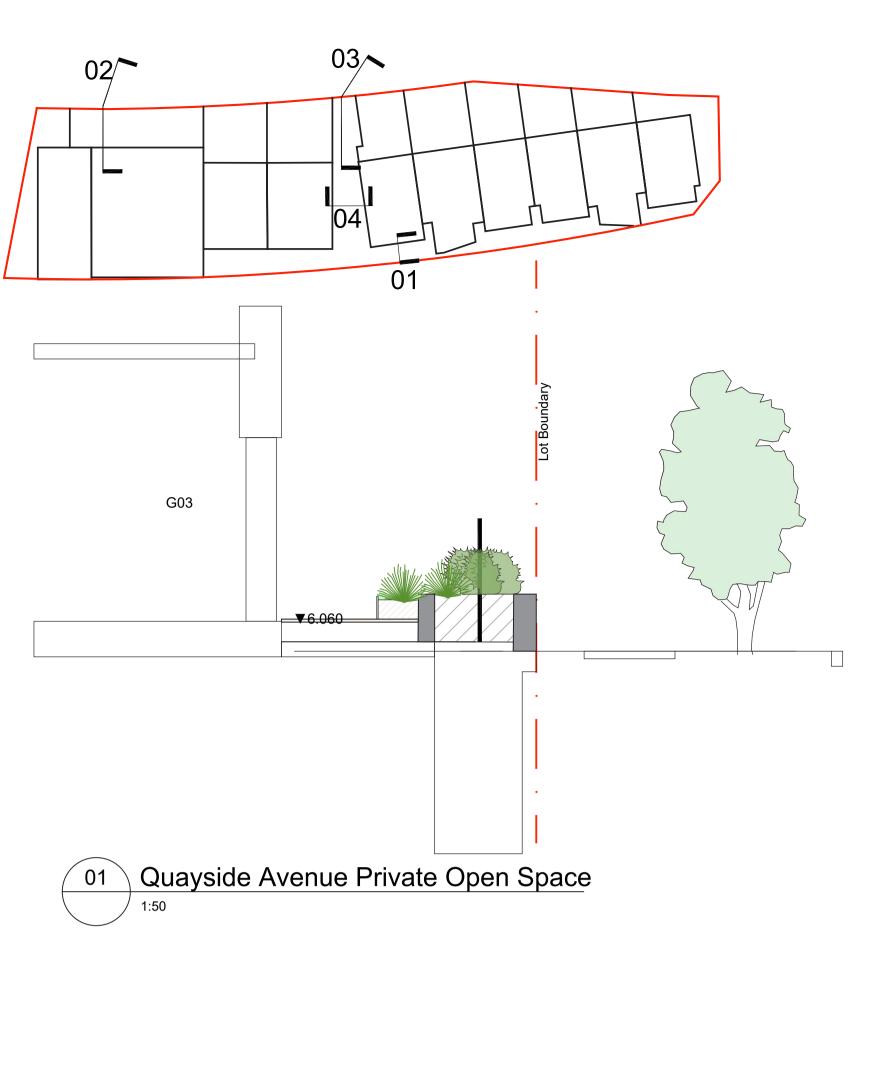
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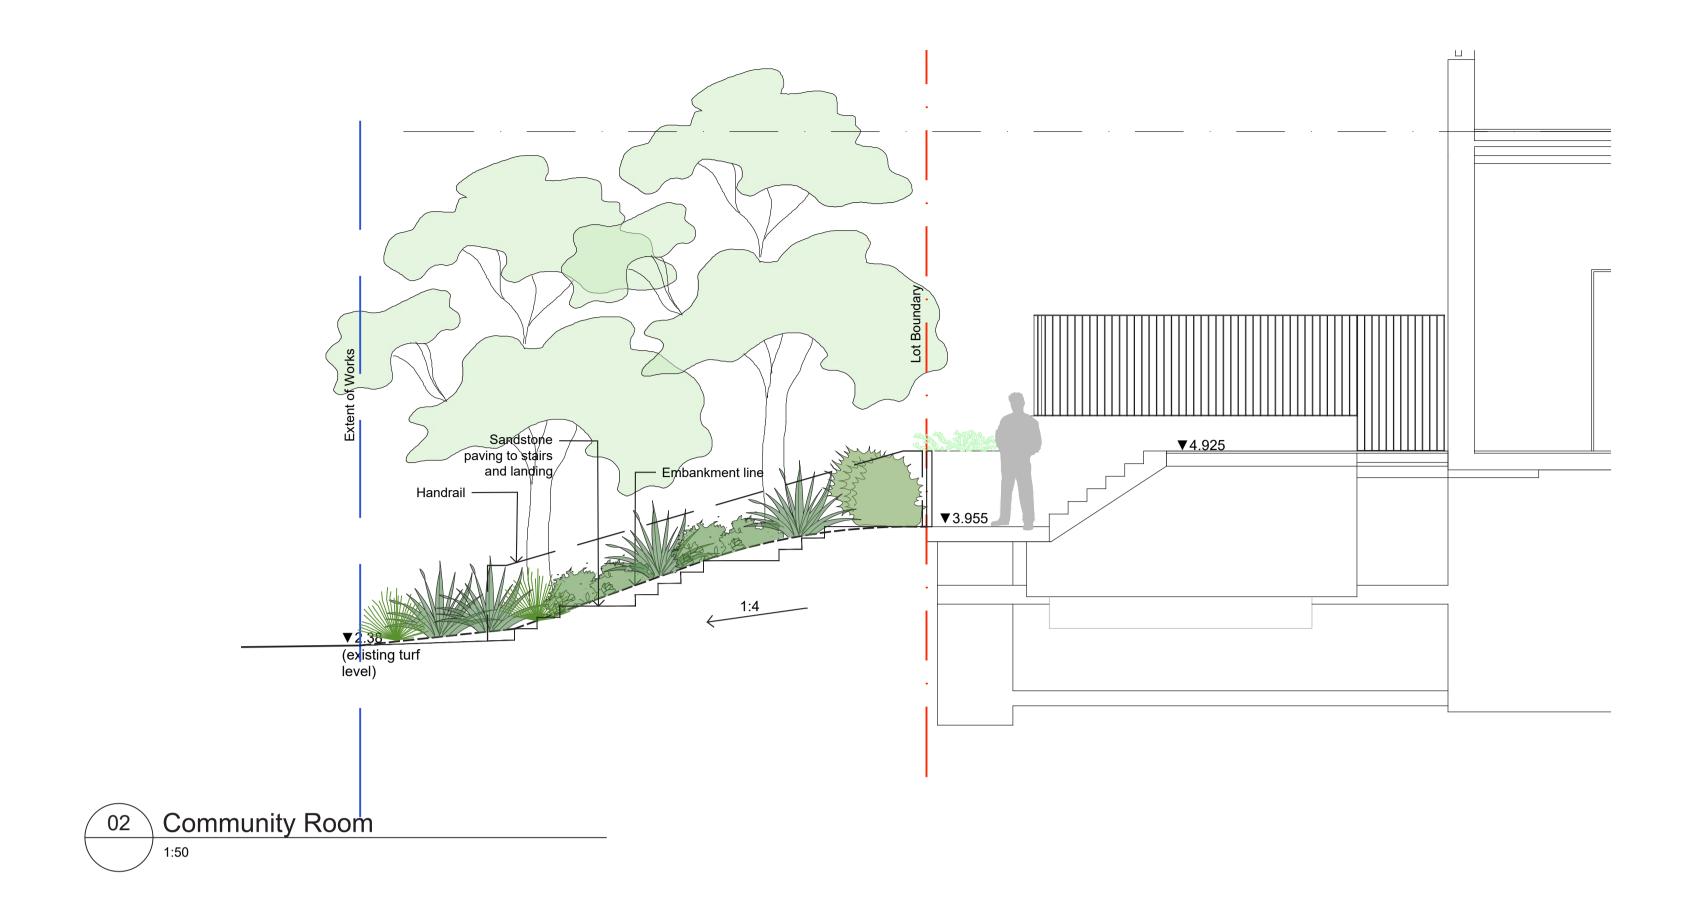
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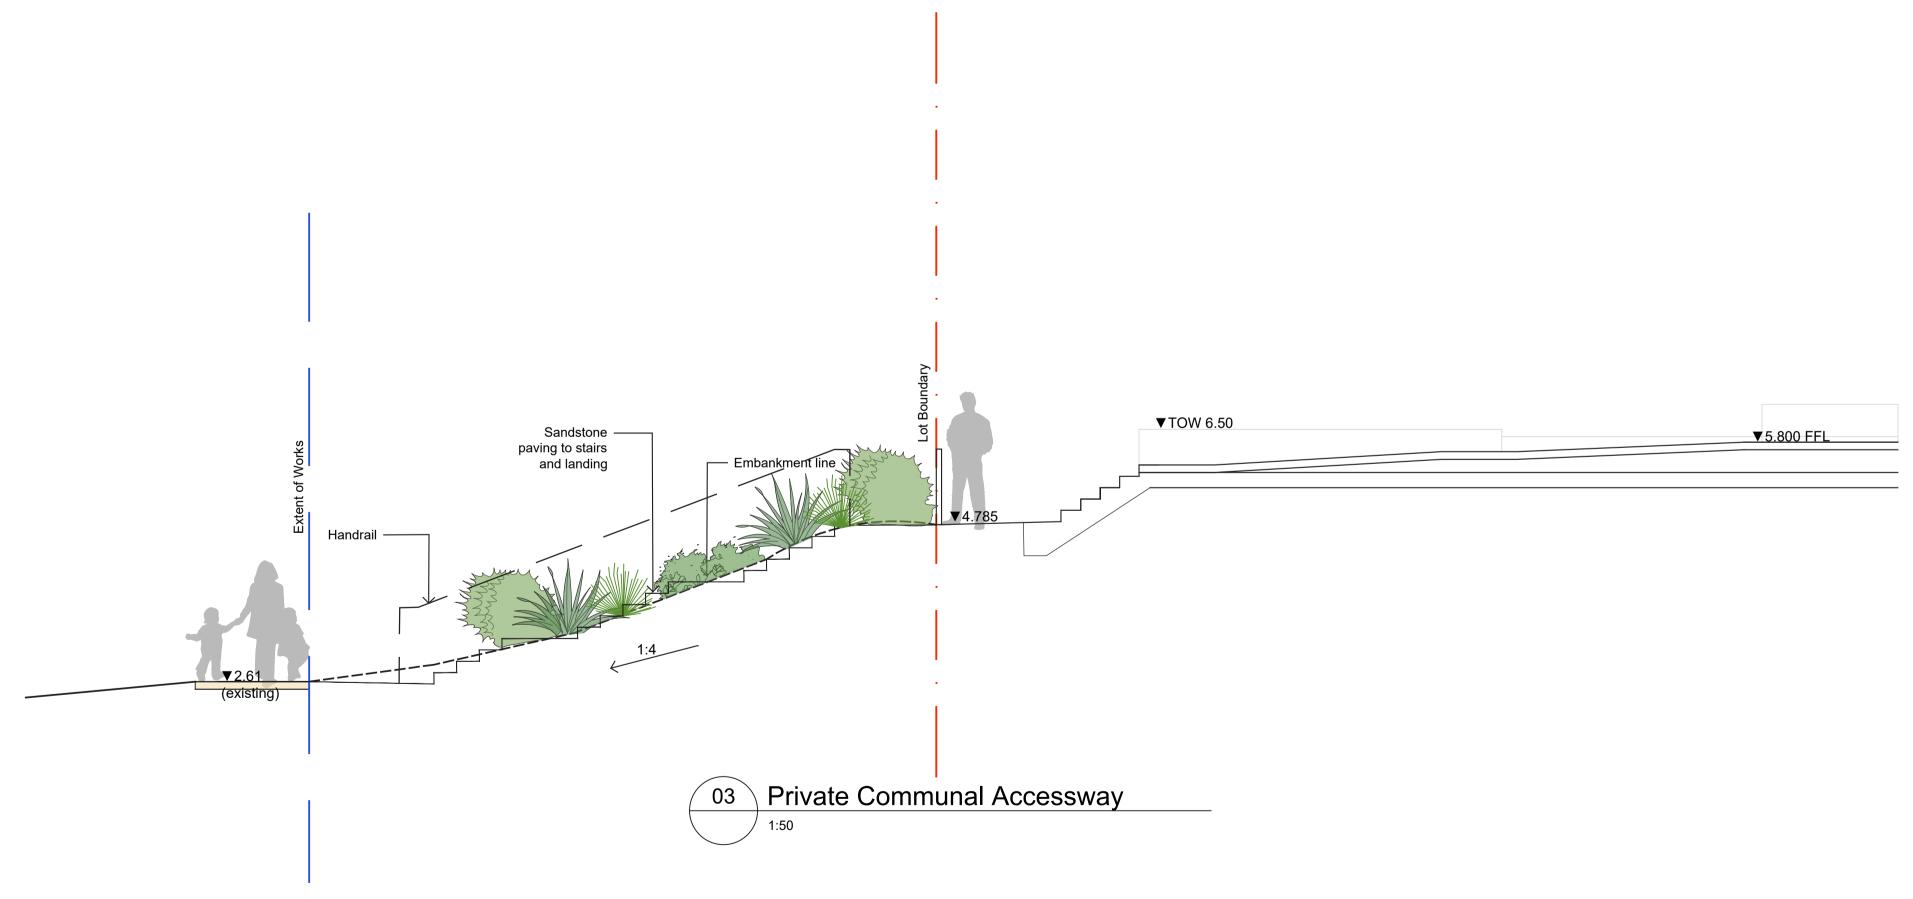
Precinct C2 Shell Cove

DEVELOPMENT APPLICATION

Scale: As Shown Job Number: Drawing Number: SS21-4673 503 E









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Private Communal Accessway

Client:
Fras

Landscape Architects
Level 1, 3-5 Baptist Street
Redfern NSW 2016
Australia

Tel: (61 2) 8332 5600
Fax: (61 2) 9698 2877

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Drawing Name:

Landscape Sections

Project:
Precinct C2
Shell Cove

DEVELOPMENT APPLICATION

Scale: 1:50 @ A1


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DEVELOPMENT APPLICATION


Drawing Number:
Drawing Numb

SS21-4673

601 E



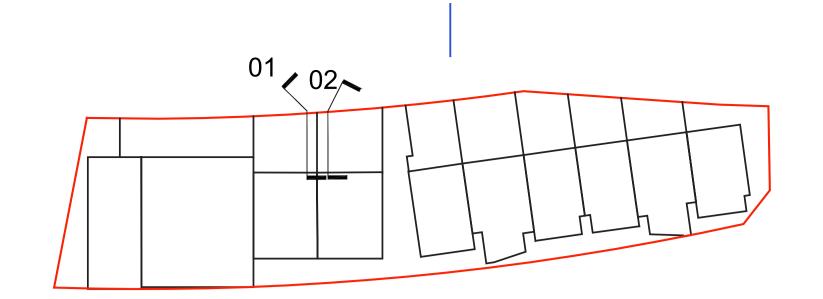

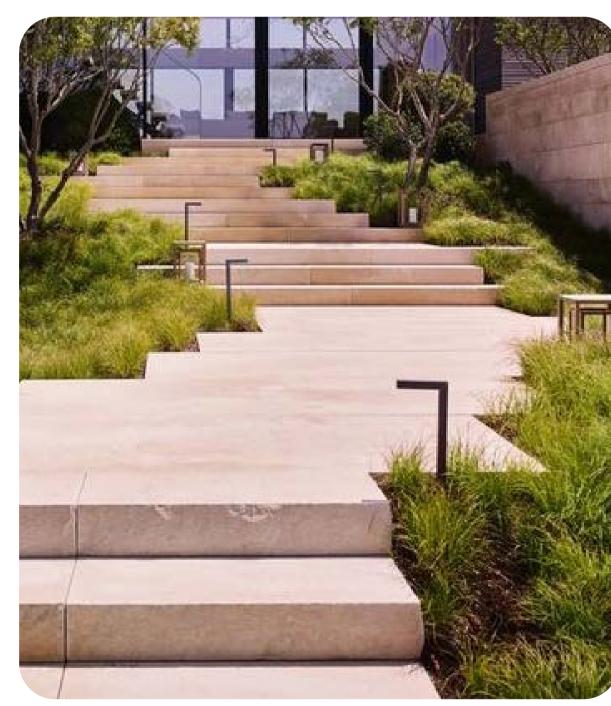

▼5.390 G01 Sandstone paving to stairs and landing ▼TOW 5.390 ▼5.390 Embankment Line Handrail — Existing ——turf level 02 G02

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E Forshore Stairs Updated CK
D Foreshore Tree Species Modified JD
C Development Application JD
B Development Application JD

A Preliminary

Issue Revision Description

CK NM 01.02.2022


Modified JD NM 20.01.2022

JD NM 16.09.2021

JD NM 14.09.2021

JD NM 03.09.2021

Drawn Check Date

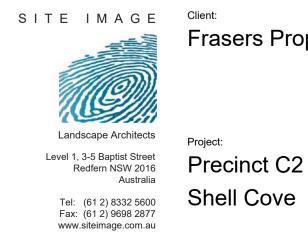


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Drawing Name:

Landscape Sections

DEVELOPMENT APPLICATION



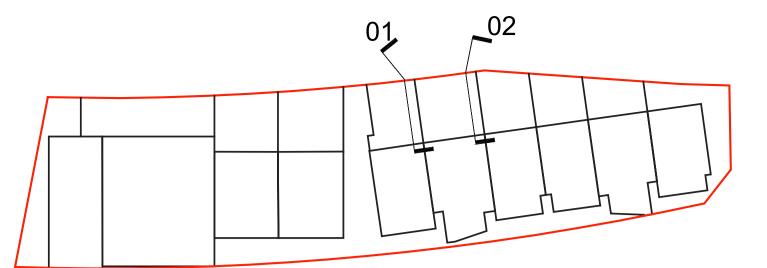



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CK NM 01.02.2022 Forshore Stairs Updated Foreshore Tree Species Modified JD NM 20.01.2022 **Development Application** JD NM 16.09.2021 JD NM 14.09.2021 B Development Application A Preliminary JD NM 03.09.2021 Drawn Check Date

Issue Revision Description



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Drawing Name: Landscape Sections

DEVELOPMENT APPLICATION

Scale: 1:50 @ A1 Job Number: Drawing Number: 603 E SS21-4673



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D Foreshore Tree Species Modified JD NM 20.01.2022
C Development Application JD NM 16.09.2021
B Development Application JD NM 14.09.2021
A Preliminary JD NM 03.09.2021
Issue Revision Description Drawn Check Date



Frasers Property Australia

Drawing Name:

Landscape Sections


Project:
Precinct C2
Shell Cove


DEVELOPMENT APPLICATION

Scale: 1:50 @ A1 0 0.5 1 1.5 2 2.5m

Job Number: Drawing Number: Issue:

SS21-4673 604 E

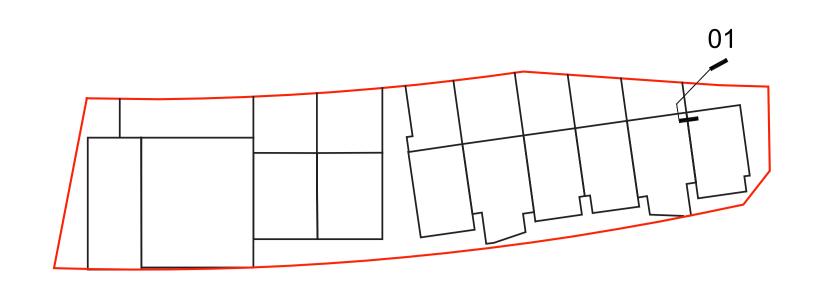

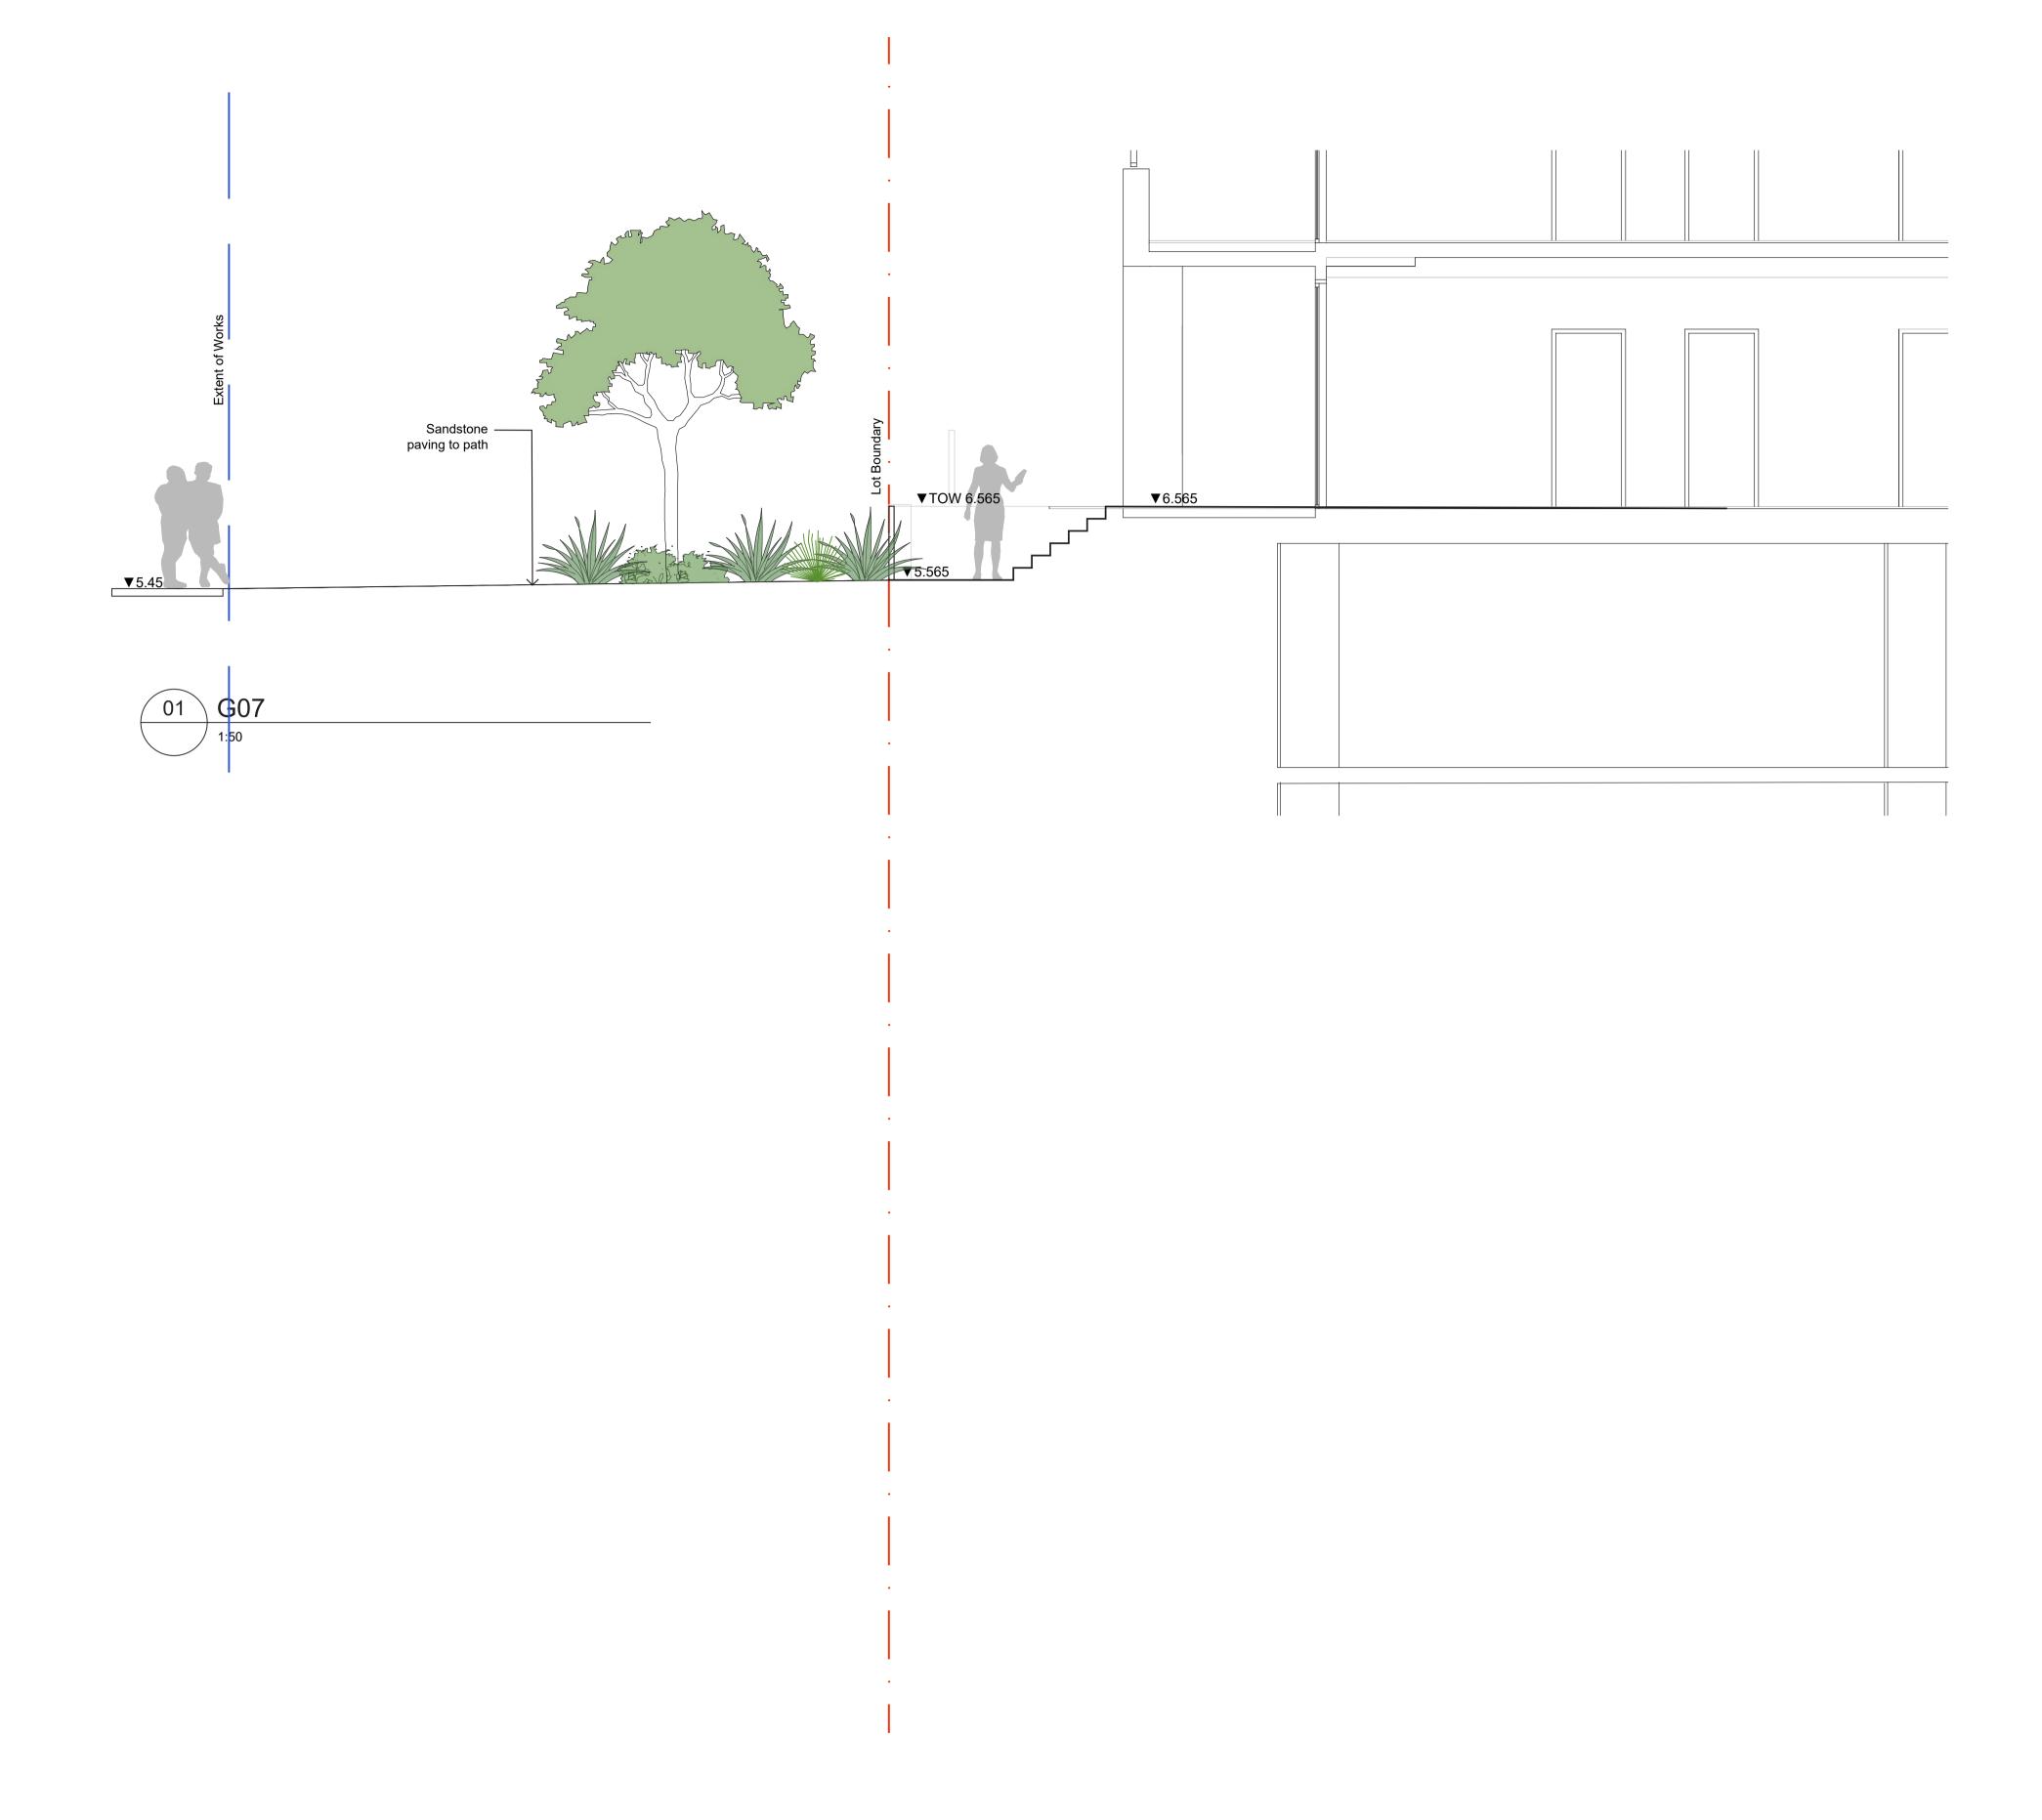

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Shell Cove

Drawing Name:

Landscape Sections

DEVELOPMENT APPLICATION